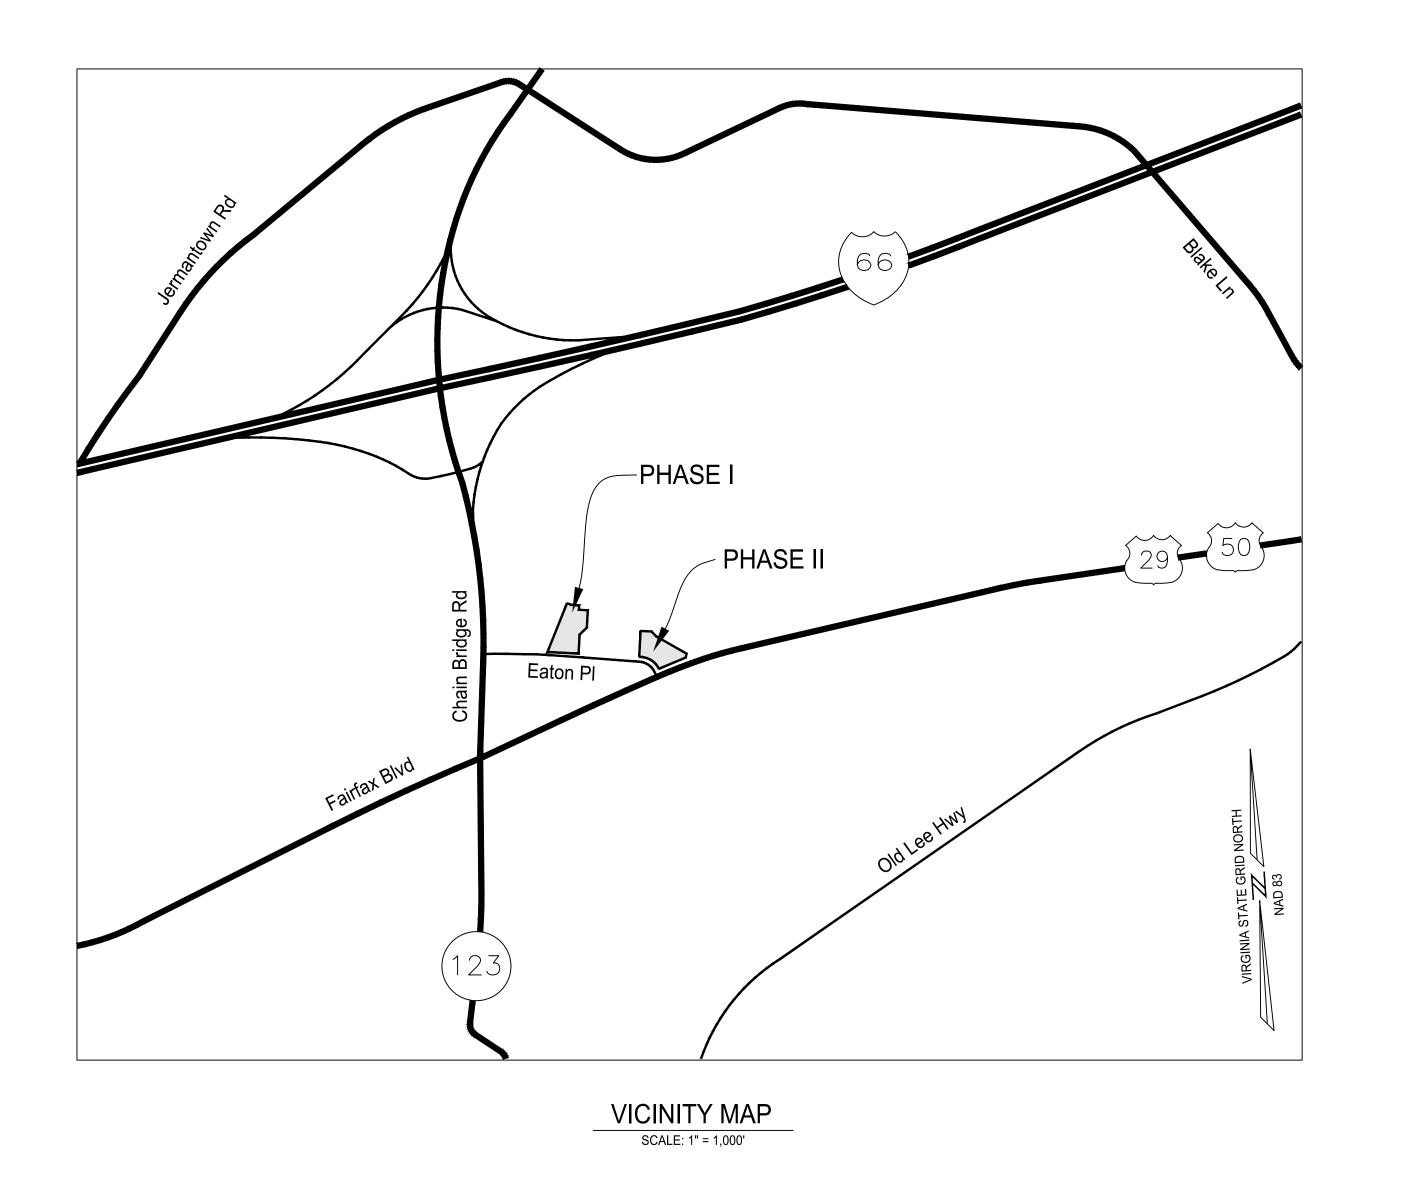
GENERAL DEVELOPMENT PLAN PHASE I: N29 APARTMENTS

CITY OF FAIRFAX, VIRGINIA

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PROJECT TEAM:

CONTRACT PURCHASER/ APPLICANT CAPITAL CITY REAL ESTATE 3000 K STREET, NW SUITE 270 WASHINGTON, DC, 20007

OWNER

WILLOWWOOD OFFICE OWNER LLC 10300 EATON PLACE FAIRFAX, VA 22030

ATTORNEY

COZEN O'CONNOR 1200 19TH STREET NW, 3RD FLOOR WASHINGTON, DC 20036

ARCHITECT


hickok cole 301 N STREET NW WASHINGTON, DC 20002

ENGINEER & LANDSCAPE ARCHITECT christopher consultants
4035 RIDGE TOP ROAD, SUITE 601
FAIRFAX, VA 22030


TRAFFIC ENGINEER
WELLS + ASSOCIATES
1420 SPRING HILL ROAD, SUITE 610
TYSONS, VA 22102

christopher Consultants



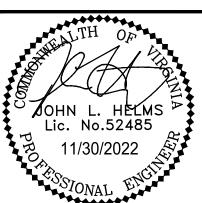

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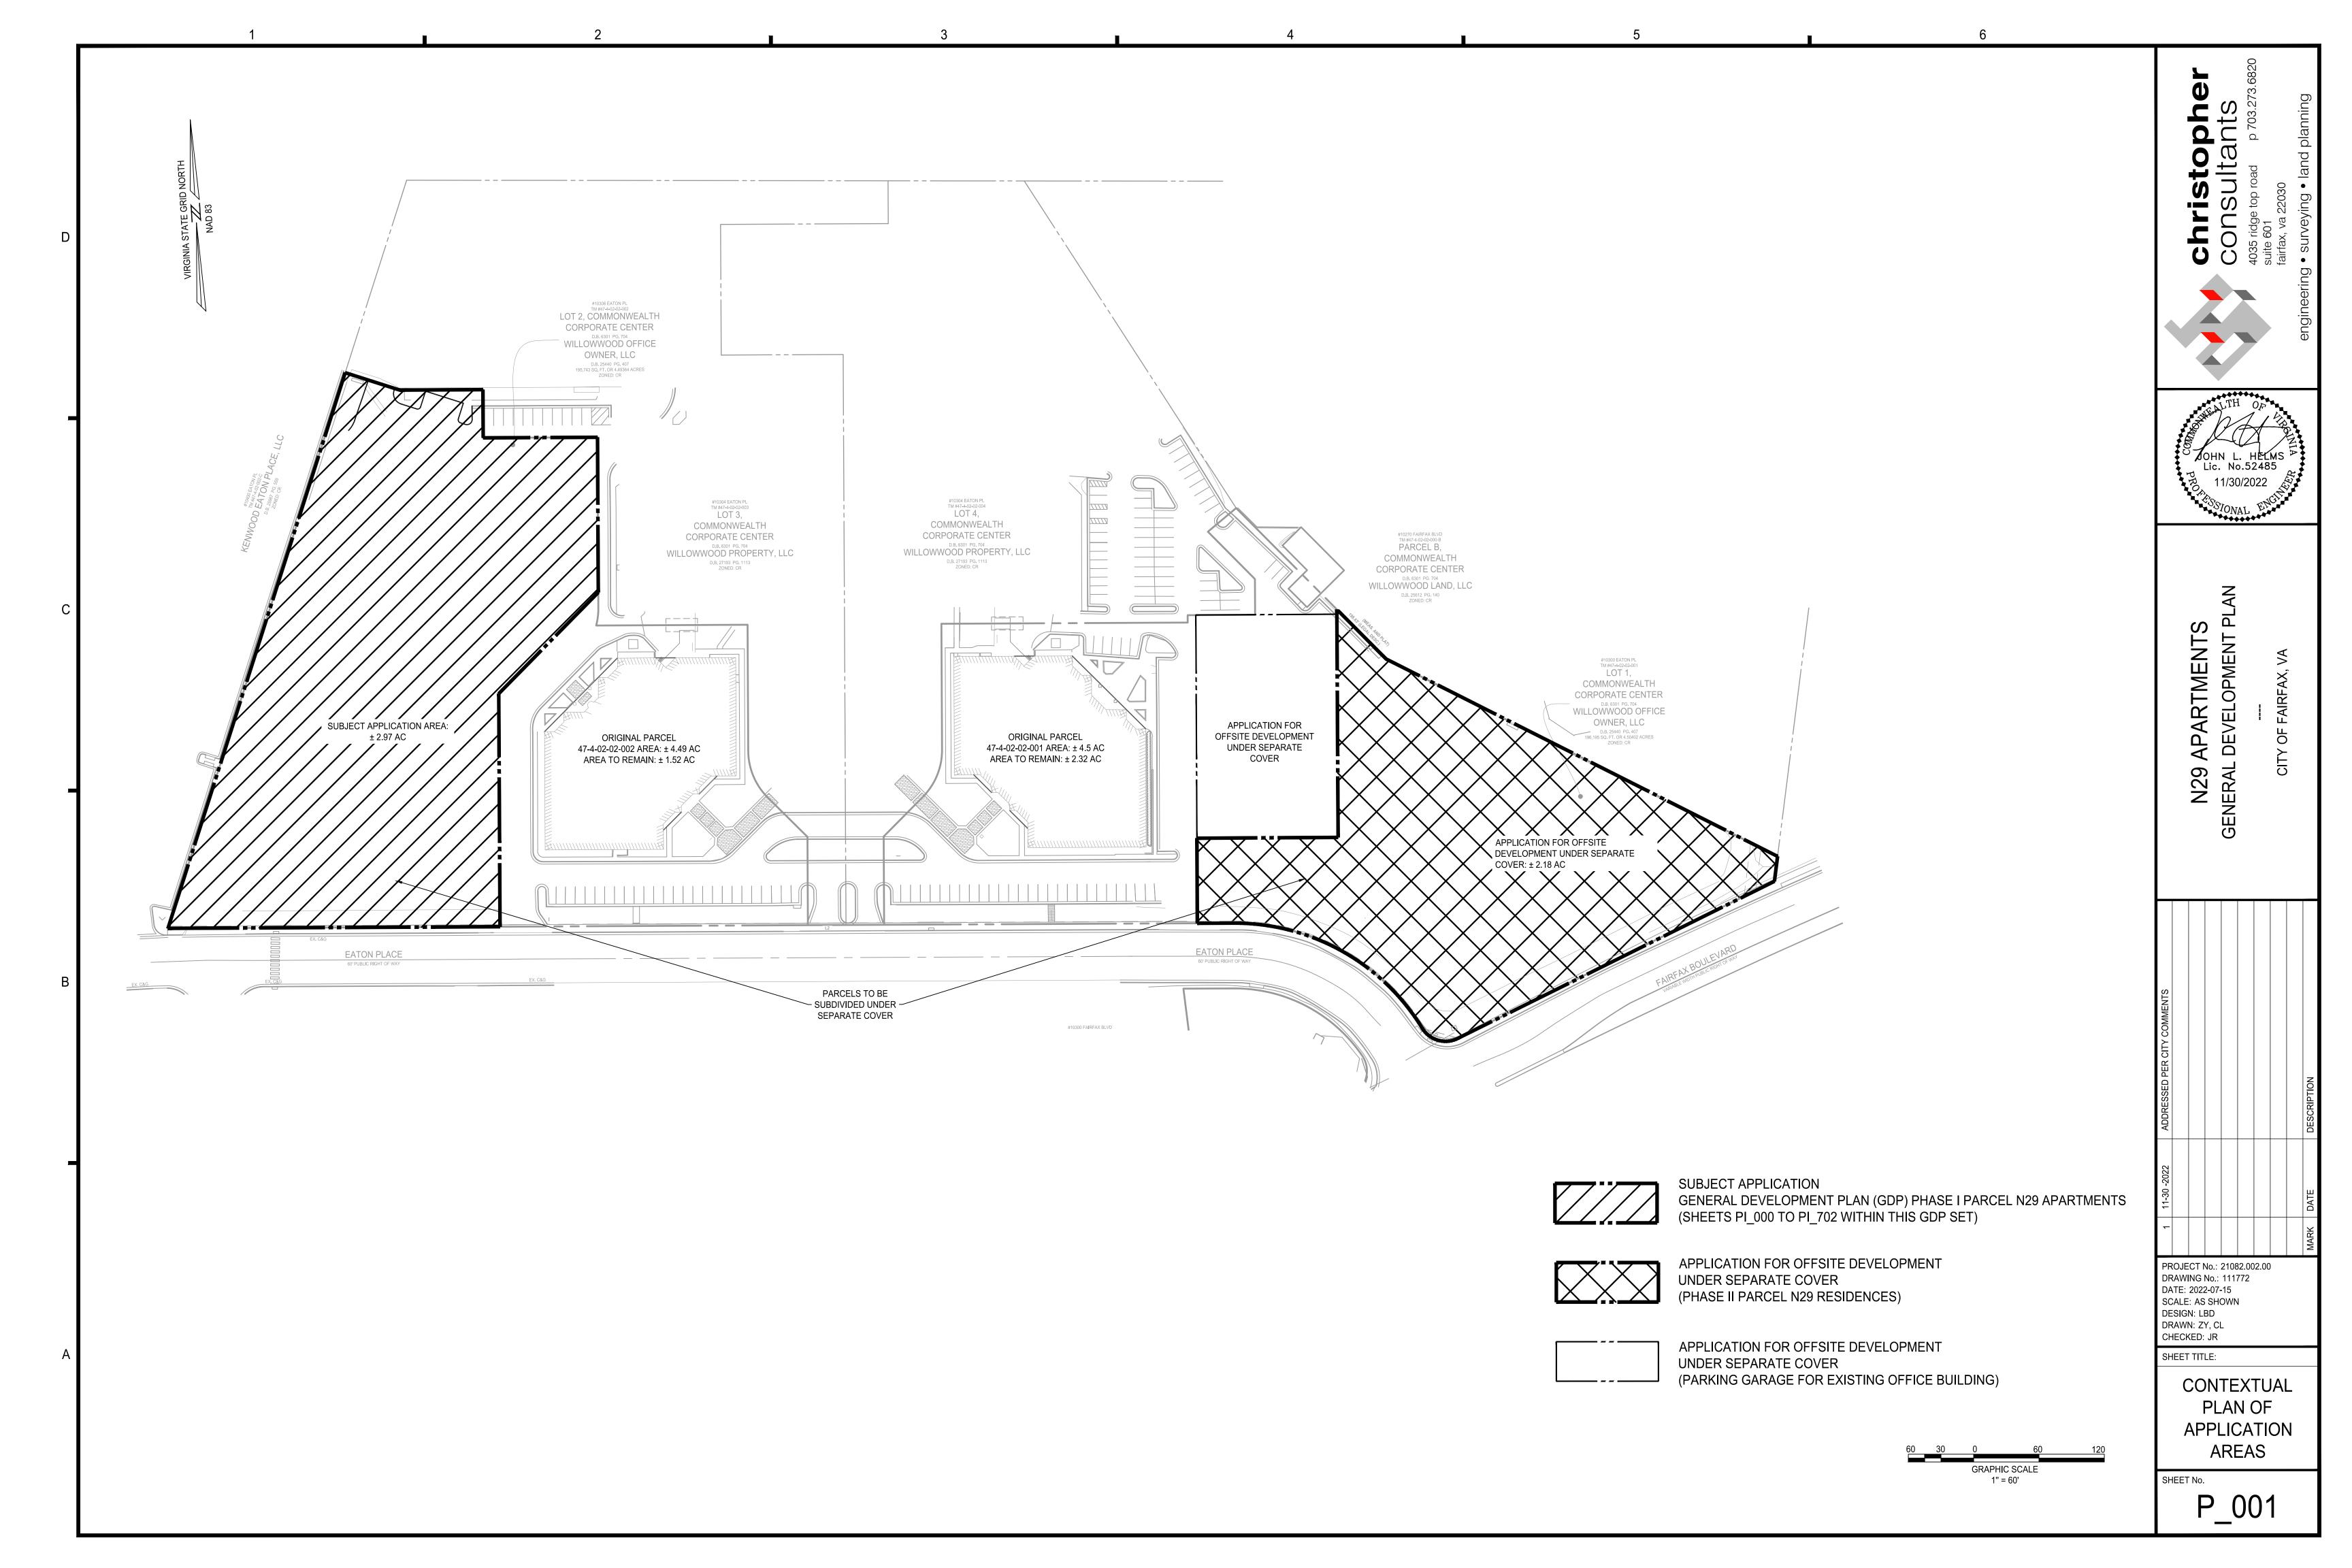
PROJECT No.: 21082.002.00
DRAWING No.: 111772
DATE: 2022-07-15
SCALE: 1"= 100'
DESIGN: LBD
DRAWN: ZY
CHECKED: JR

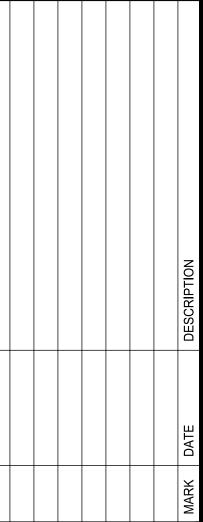SHEET TITLE:

COVER SHEET

SHEET No.

P_000




GENERAL NOTES: RECORDED IN THE LAND RECORDS OF FAIRFAX CITY, VIRGINIA: <u>ADDRESS</u> EXISTING ZONING 47-4-02-02-002 WILLOWWOOD OFFICE OWNER, LLC 10306 EATON PLACE CR (COMMERCIAL RETAIL) ± 4.49 ACRES CR AS EXISTING OFFICE USE, AND WILL NOT BE A PART OF THIS APPLICATION. CHRISTOPHER CONSULTANTS, LTD BETWEEN THE DATES OF MARCH 22 AND MAY 5, 2022. ELECTRIC, GAS, TELEPHONE, CATV, WATER, SANITARY AND STORM SEWERS. CONSULTANTS, LTD SERVICES FOR THE PROJECT AS SHOWN HEREON. ELECTRIC, GAS, TELEPHONE, CATV, WATER, SANITARY AND STORM SEWERS. 8. DURING THE PROCESS OF PHYSICAL SURVEY NO INDICATIONS OF A CEMETERY WERE FOUND. NO FURTHER INSPECTION OF THIS PROPERTY HAS BEEN MADE FOR POSSIBLE CEMETERIES. VIDEO CAMERA OPERATED BY THIS FIRM ON THE DATE OF APRIL 20th, 2022. "WILLOWWOOD PLAZA SITE PLAN PHASE ONE" WITH A REVISION DATE OF NOVEMBER 10th, 1986. EFFECTIVE DATE OF 06/02/2006 AND A REVISION DATE OF 10/11/2019. BY GRAPHIC DEPICTION ONLY, THE PROPERTY SHOWN HEREON IS SHOWN IN: LESS THAN ONE SQUARE MILE. EMERGENCY MANAGEMENT AGENCY. AND FAIRFAX WATER. ADVERSE EFFECTS TO NEIGHBORING PROPERTIES ARE ANTICIPATED WITH THIS PROJECT. AND PLANNING. DEVELOPMENT PLAN. SECTION 2.10 OF THE PUBLIC FACILITIES MANUAL. ARE SHOWN ON SHEETS WITHIN THIS PLAN SET. 18. ALL SIGNAGE WILL BE IN CONFORMANCE WITH SECTION 4.6 OF THE ZONING ORDINANCE. SUMMARY AND SHARED PARKING ANALYSIS IS INCLUDED WITH THIS APPLICATION UNDER SEPARATE COVER. (OR EDGE OF PAVEMENT).

- 1. THE SUBJECT PROPERTY IS A PORTION (± 2.97 AC) THAT WILL BE SUBDIVIDED FROM THE FOLLOWING PARCEL AND IS
- 2. THIS GDP SUBMISSION IS AN APPLICATION TO REZONE THE SUBJECT PROPERTY FROM CR (COMMERCIAL RETAIL) TO CU (COMMERCIAL URBAN) DISTRICT. THE DEVELOPMENT PROGRAM ON THE SUBJECT PROPERTY WILL INCLUDE MULTI-FAMILY HOUSING, RETAIL, AND LIVE/WORK UNITS. THE REMAINDER OF THE ORIGINAL PARCEL WILL REMAIN ZONED
- 3. HORIZONTAL DATUM SHOWN HEREON IS REFERENCED TO THE VIRGINIA COORDINATE SYSTEM (VCS) 1983 NORTH AS ESTABLISHED FROM A CURRENT GPS SURVEY. VERTICAL DATUM SHOWN HEREON IS REFERENCED TO THE NATIONAL GEODETIC VERTICAL DATUM OF 1929 (NGVD 29) (GEOID-18) AS ESTABLISHED FROM A CURRENT GPS SURVEY.
- 4. THE PHYSICAL IMPROVEMENTS AND TOPOGRAPHY SHOWN HEREON ARE BASED UPON A FIELD SURVEY CONDUCTED BY
- 5. NO CERTIFICATION HAS BEEN MADE AS TO THE LOCATIONS OF UNDERGROUND UTILITIES SUCH AS, BUT NOT LIMITED TO
- 6. NO GEOTECHNICAL, SUBSURFACE, FIELD REVIEWS, RESEARCH, AGENCY OR GOVERNMENTAL RECORD REVIEWS, OR OTHER INVESTIGATIONS HAVE BEEN MADE FOR THE PURPOSE OF LOCATING, OR DETERMINING THE EXISTENCE OF HAZARDOUS MATERIALS, OR OTHER ENVIRONMENTAL CONCERNS ON SITE IN THE PERFORMANCE OF CHRISTOPHER
- 7. NO CERTIFICATION HAS BEEN MADE AS TO THE LOCATIONS OF UNDERGROUND UTILITIES SUCH AS, BUT NOT LIMITED TO
- 9. STORM AND SANITARY INVERTS, PIPE SIZES AND MATERIALS HAVE BEEN DETERMINED THROUGH THE USE OF A SEWER
- 10. THE LIMITS OF THE UNDERGROUND BMP FACILITY SHOWN HERON ARE APPROXIMATE AND BASED OFF OF A PLAN TITLED
- 11. THE AREA SHOWN HEREON IS LOCATED ON THE FLOOD INSURANCE RATE MAP (FIRM), NO. 5155240002D, WITH AN
- FLOOD ZONE "AE" (SPECIAL FLOOD HAZARD AREAS SHADED), AREAS WITH BASE FLOOD ELEVATION (BFE) OR
- FLOOD ZONE "X" (OTHER AREAS OF FLOOD HAZARD SHADED), 0.2% ANNUAL CHANCE FLOOD HAZARD, AREAS OF 1% ANNUAL CHANCE FLOOD WITH AVERAGE DEPTH LESS THAN ONE FOOT OR WITH DRAINAGE AREAS OF
- FLOOD ZONE "X" (OTHER AREAS), AREAS DETERMINED TO BE OUTSIDE THE 500-YEAR FLOODPLAIN.

A FIELD SURVEY WAS NOT PERFORMED TO DETERMINE THE FLOOD ZONES LISTED HEREON. AN ELEVATION CERTIFICATE MAY BE NEEDED TO VERIFY THIS DETERMINATION OR APPLY FOR A VARIANCE FROM THE FEDERAL

- 12. THE SUBJECT PROPERTY IS CURRENTLY SERVED BY PUBLIC WATER AND PUBLIC SEWER PROVIDED BY CITY OF FAIRFAX
- 13. THIS DEVELOPMENT PROPOSAL IS COMPATIBLE WITH THE EXISTING DEVELOPMENT IN THE VICINITY OF THIS SITE. NO
- 14. NOTWITHSTANDING THE IMPROVEMENTS AND TABULATIONS SHOWN ON THIS PLAN, THE APPLICANT RESERVES THE RIGHT TO MAKE MINOR MODIFICATIONS TO THE FINAL DESIGN, TO COMPLY WITH FINAL ENGINEERING AND NEW CRITERIA AND REGULATIONS WHICH MAY BE ADOPTED BY THE CITY OF FAIRFAX SUBSEQUENT TO THE SUBMISSION OF THIS APPLICATION, PROVIDED THAT SUCH MODIFICATIONS ARE SUBSTANTIALLY CONSISTENT WITH THE APPROVED DEVELOPMENT PLAN AND COMMITMENTS AND SUBJECT TO THE DETERMINATIONS OF THE DIRECTOR OF DEVELOPMENT
- 15. THE PROPOSED BUILDING FOOTPRINTS AND SITE IMPROVEMENTS SHOWN HEREIN ARE PRELIMINARY. THE PROPOSED SQUARE FOOTAGE FOR THE PROPOSED BUILDINGS IS APPROXIMATE ONLY AND MAY BE SUBJECT TO MINOR REVISIONS AT THE TIME OF SITE PLAN, SUBJECT TO MARKET CONDITIONS, BUT SUBSTANTIALLY CONSISTENT WITH THE APPROVED
- 16. SITE LIGHTING WITHIN THE PROJECT SITE AREA (I.E. ALONG SIDEWALKS AND PATHWAYS) WILL BE DETERMINED DURING FINAL SITE PLAN REVIEW AND SHALL BE IN GENERAL CONFORMANCE WITH SECTION 4.8 OF THE ZONING ORDINANCE AND
- 17. ONSITE STORMWATER MANAGEMENT AND BEST MANAGEMENT PRACTICES SHALL BE PROVIDED AS REQUIRED BY CITY REGULATIONS AT THE TIME OF FINAL SITE PLAN. DETENTION TO PROVIDE THE REQUIRED STORMWATER QUANTITY CONTROLS AND ONSITE BEST MANAGEMENT PRACTICES (BMPs) TO MEET THE STORMWATER QUALITY REQUIREMENTS
- 19. TO THE BEST KNOWLEDGE OF THE ENGINEER AND APPLICANT, THIS DEVELOPMENT PLAN CONFORMS TO ALL APPLICABLE ORDINANCES, REGULATIONS AND ADOPTED STANDARDS, WITH THE FOLLOWING MODIFICATION AND WAIVER REQUESTS:
- A. A MODIFICATION OF THE ZONING ORDINANCE SECTION 3.5.1.D REQUIREMENT OF 75% GROUND FLOOR NONRESIDENTIAL
- B. A MODIFICATION OF THE ZONING ORDINANCE SECTION 3.6.2 REQUIREMENT OF 24 DU/AC MAXIMUM DENSITY.
- C. A MODIFICATION OF THE ZONING ORDINANCE SECTION 3.6.2 REQUIREMENT OF 50% BUILD-TO-LINE.
- D. A MODIFICATION OF THE ZONING ORDINANCE SECTION 3.6.2 REQUIREMENT OF 5 STORY/61 FEET MAXIMUM HEIGHT.
- E. A MODIFICATION OF THE ZONING ORDINANCE SECTION 4.2.3.E PARKING RATIO REQUIREMENTS. A PARKING ANALYSIS
- F. A WAIVER OF PUBLIC FACILITIES MANUAL SECTION 401-01 REQUIREMENT THAT A TYPICAL CURB AND GUTTER STREET BE PROVIDED ON PRIVATE ACCESSWAYS THAT ARE LESS THAN THIRTY (30) FEET FROM FACE OF CURB TO FACE OF CURB



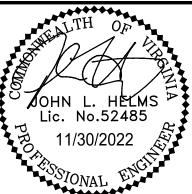



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PROJECT No.: 21082.002.00 DRAWING No.: 111772 DATE: 2022-07-15 SCALE: N/A DESIGN: LBD DRAWN: ZY, CL CHECKED: JR

SHEET TITLE:

PARCEL DIVIDER SHEET



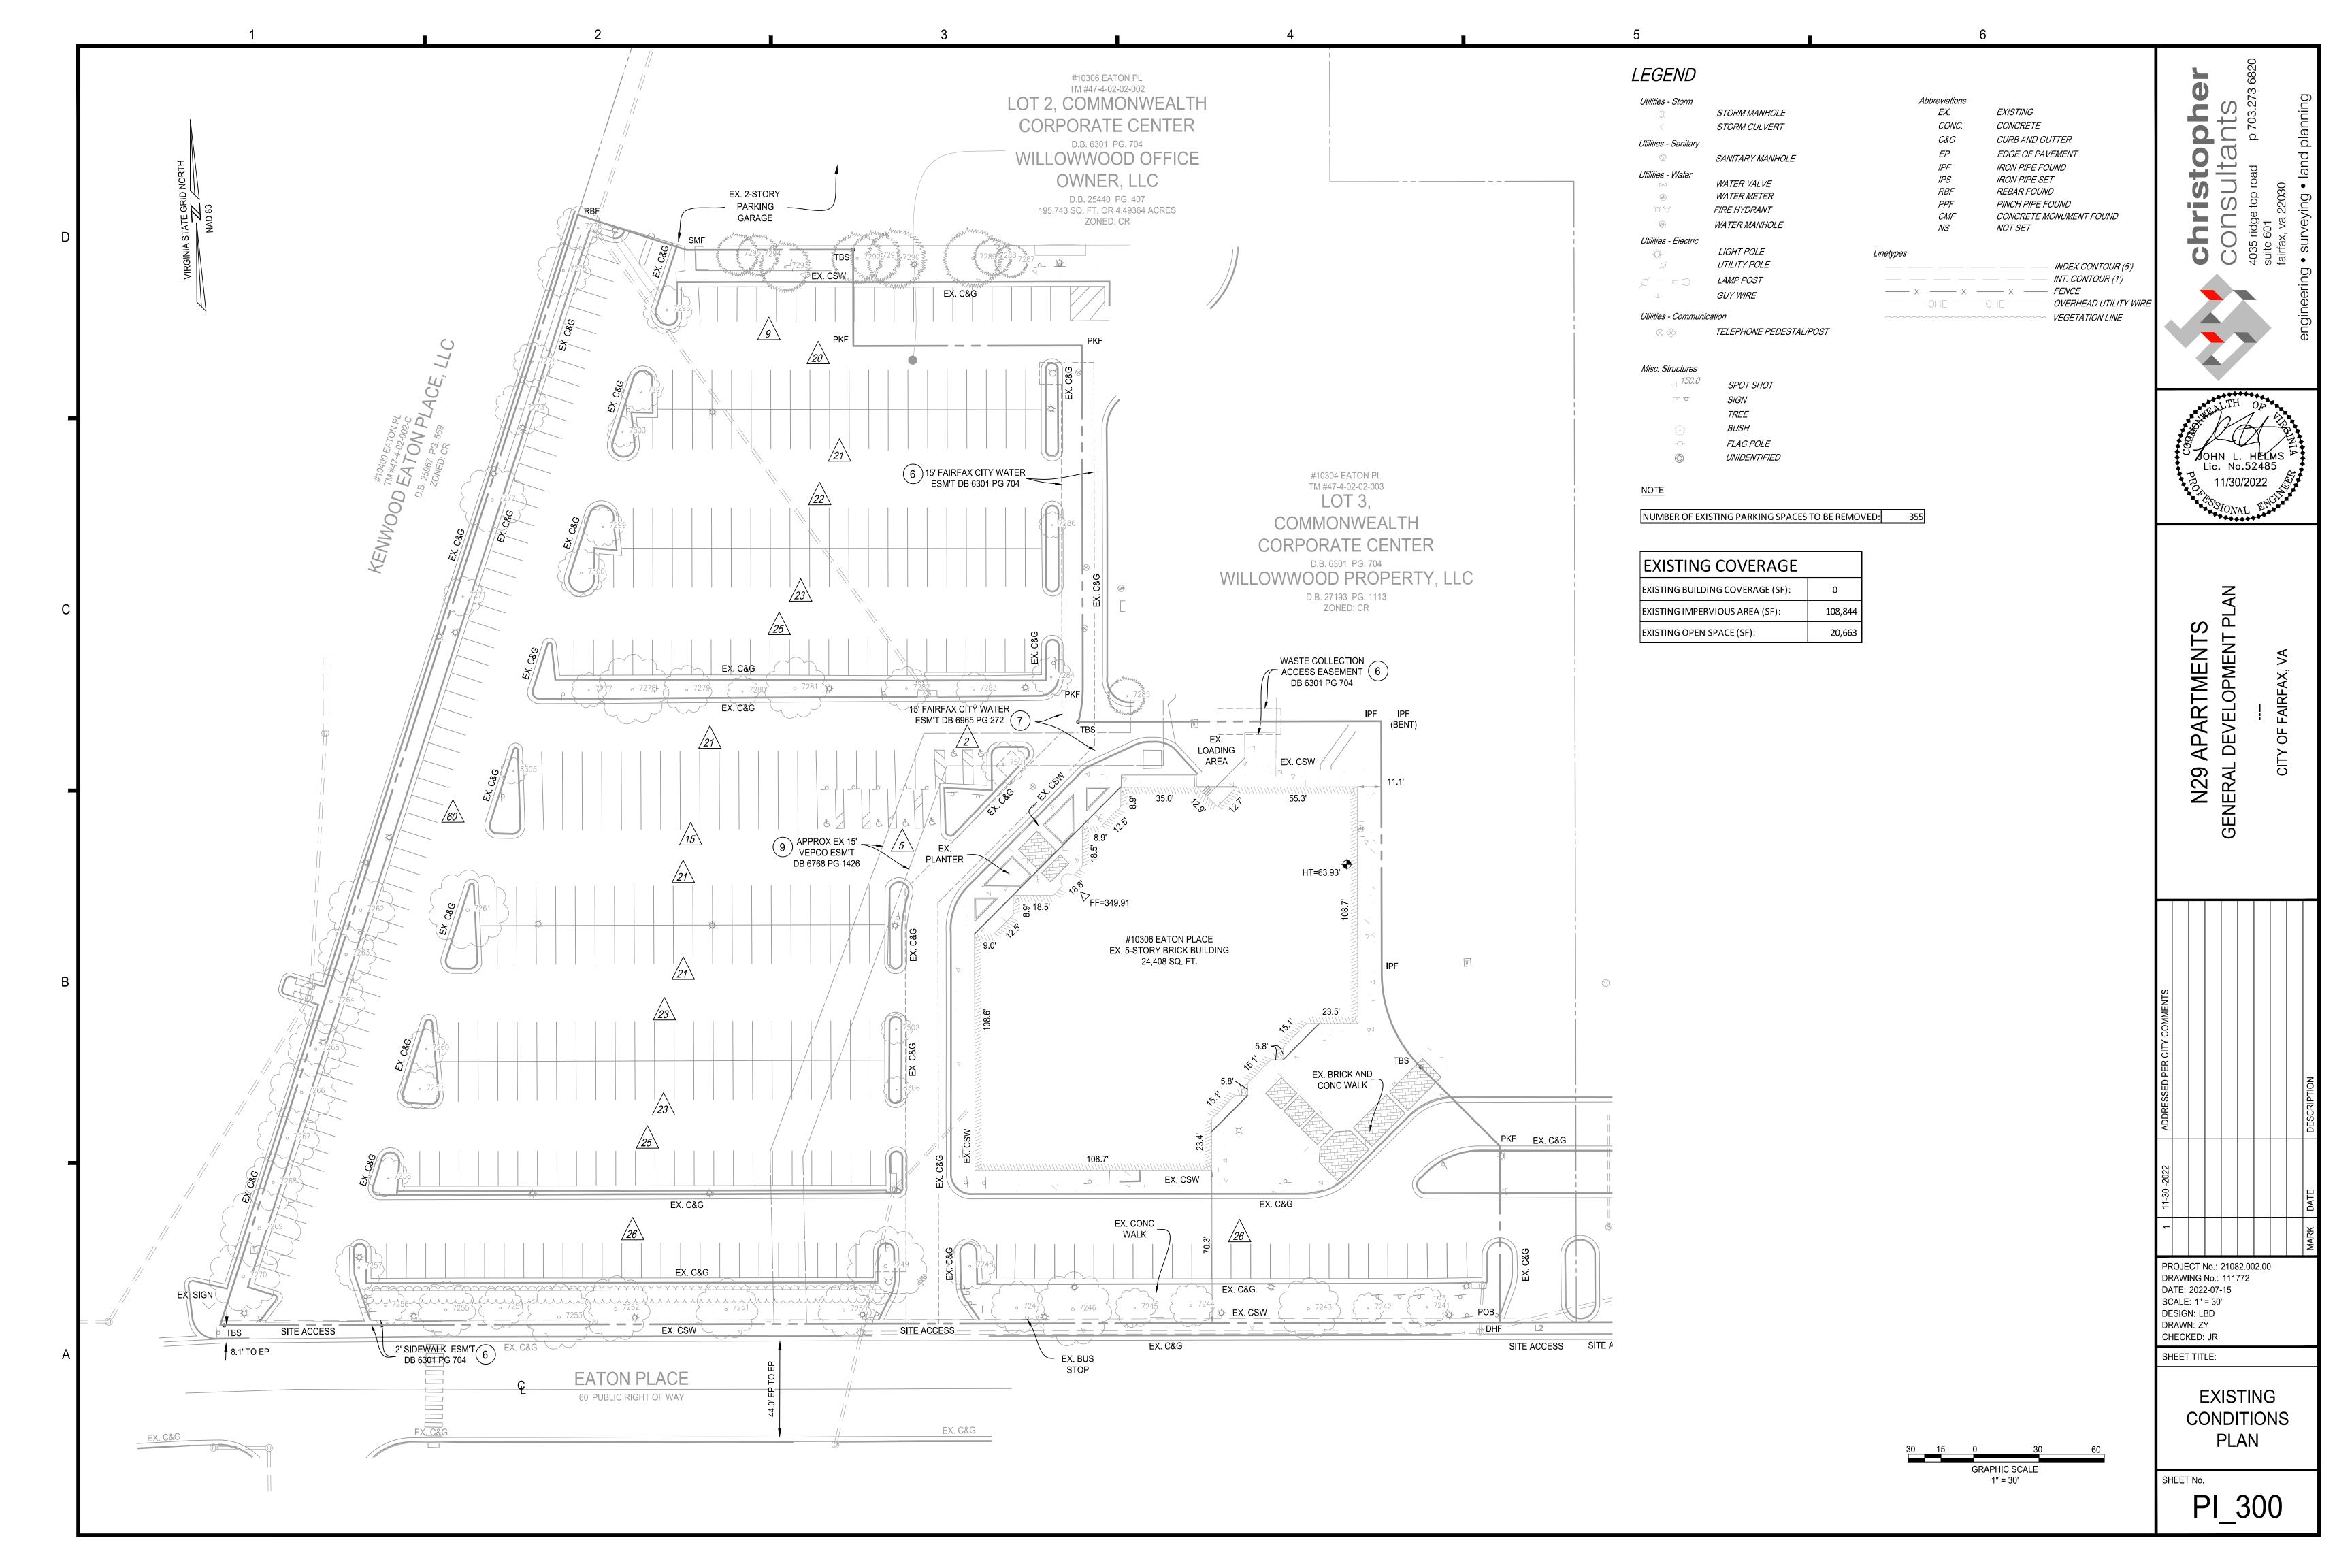

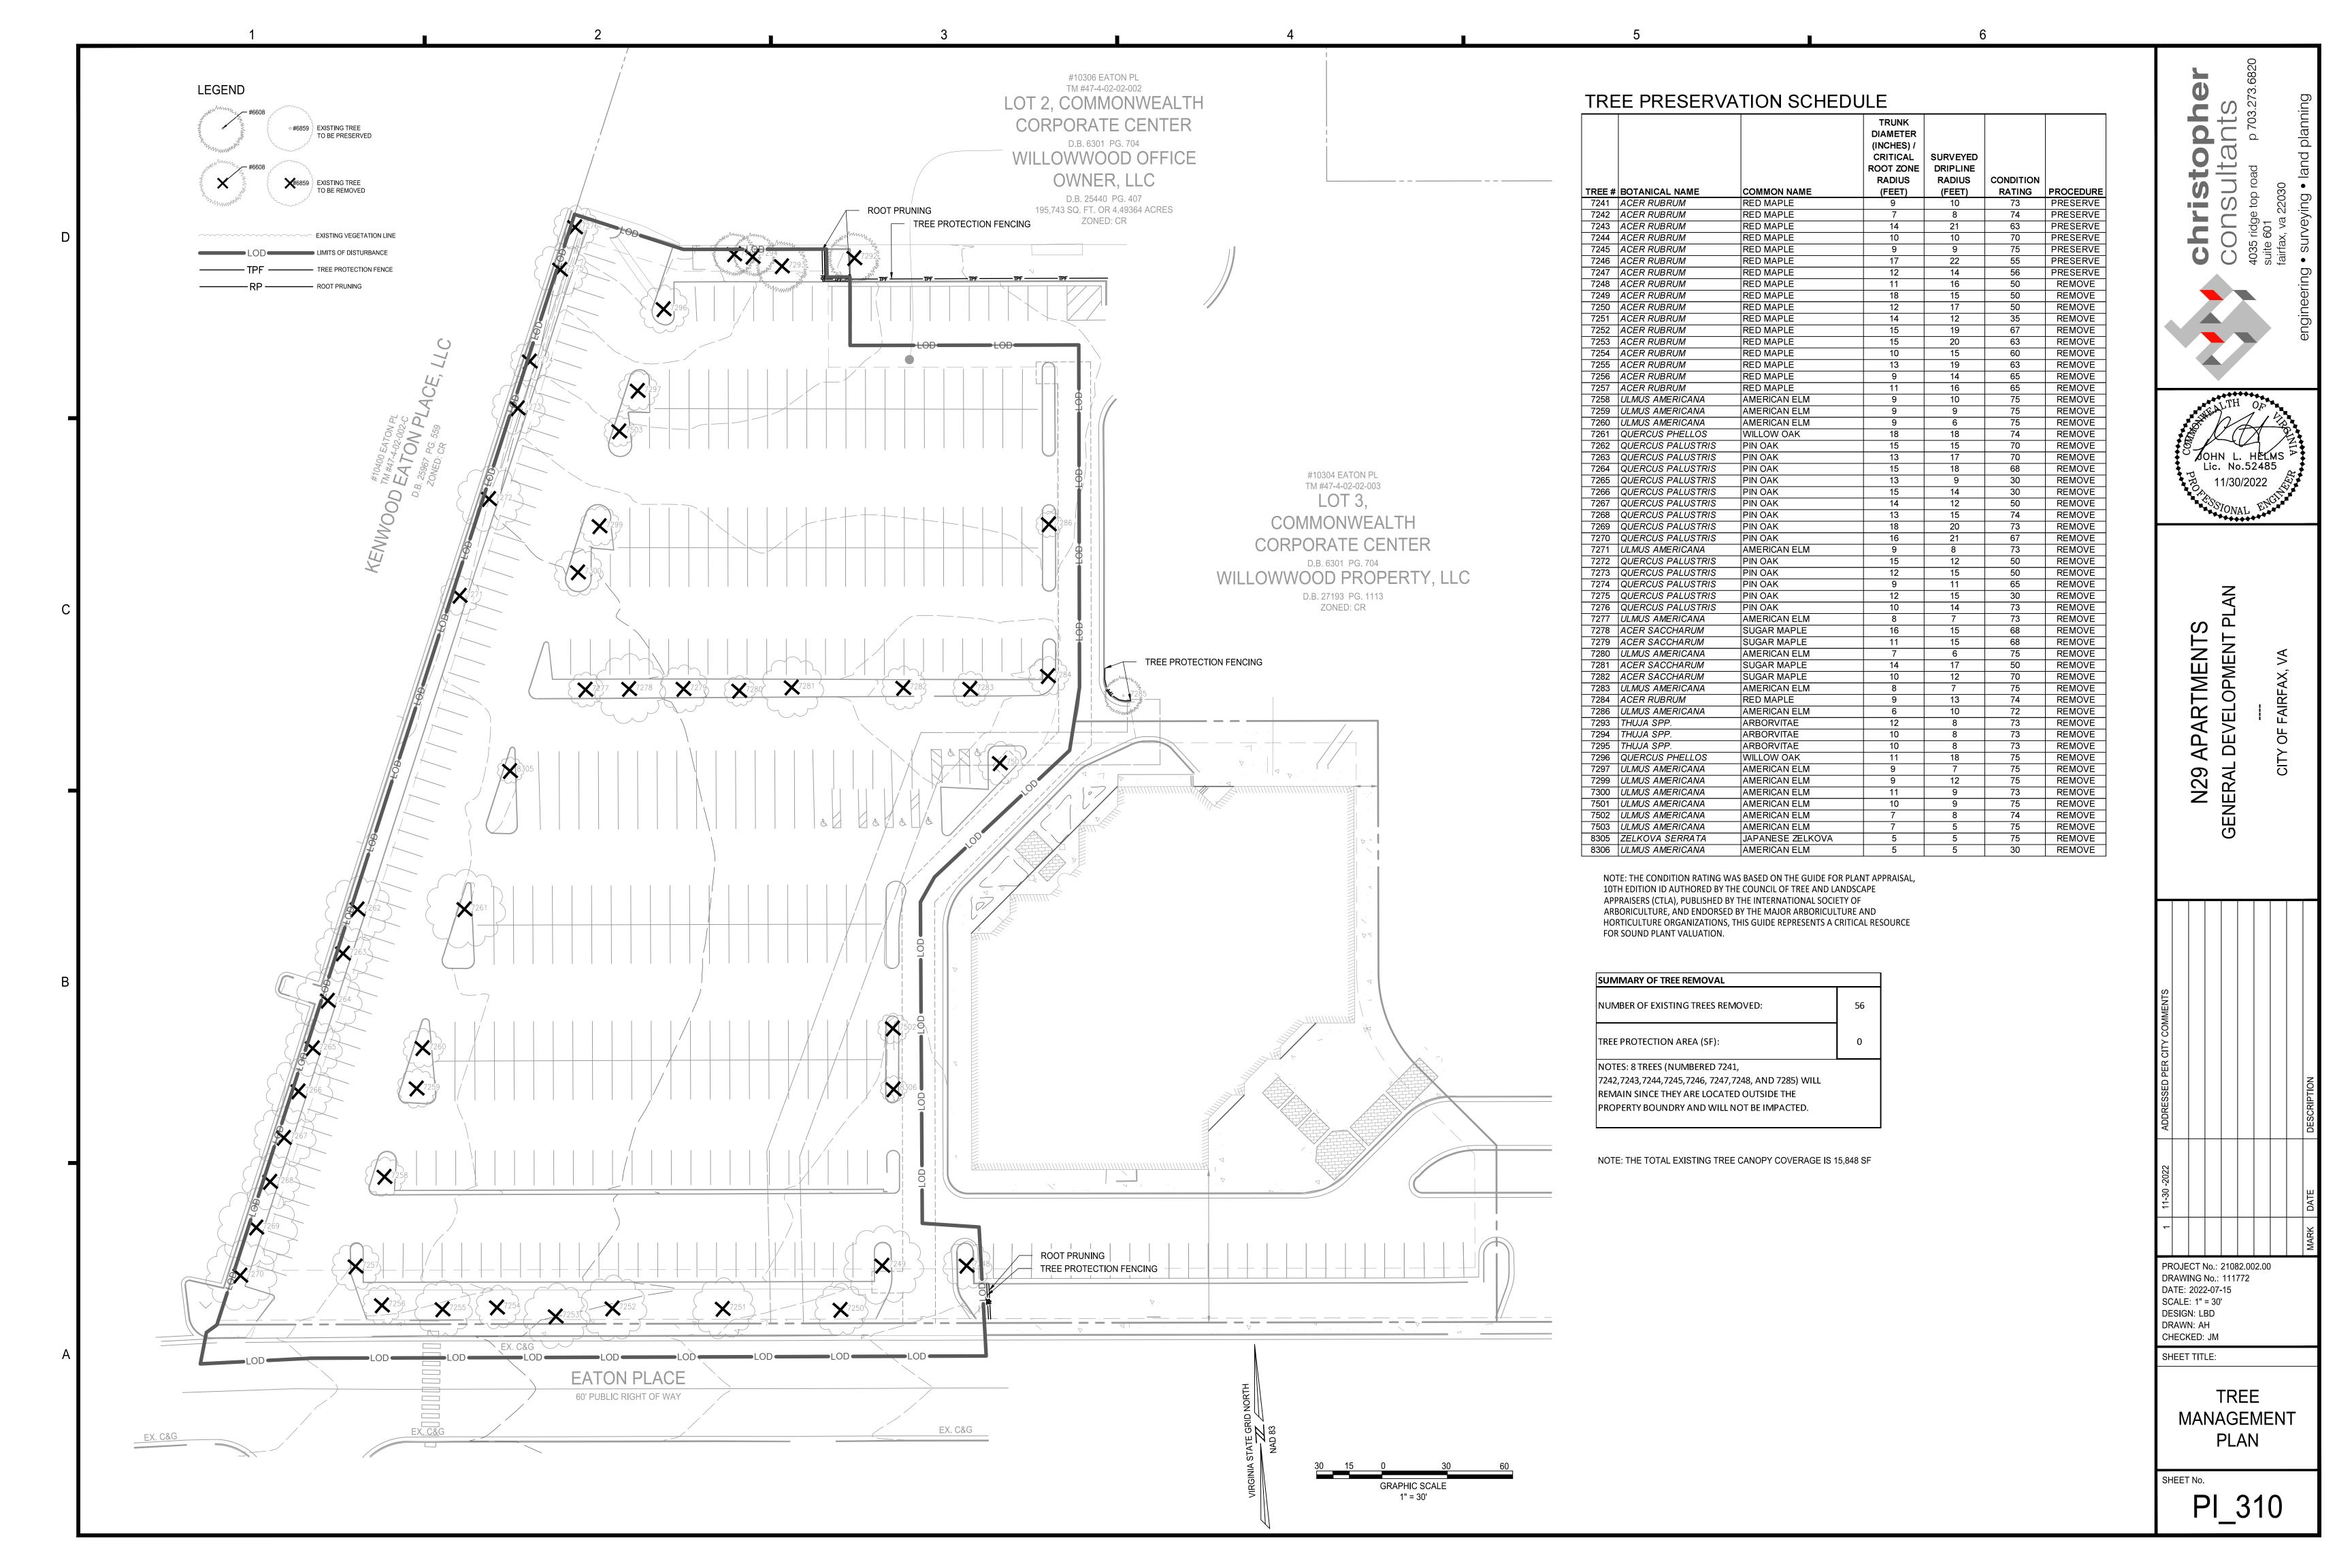- 1.1. THE REQUIREMENTS OF THE CITY OF FAIRFAX ZONING ORDINANCE AND PUBLIC FACILITIES MANUAL SHALL BE FOLLOWED.
- 1.2. ALL TREE PRESERVATION ACTIVITIES SHALL BE PERFORMED UNDER THE DIRECT SUPERVISION OF AN ISA CERTIFIED ARBORIST.
- 1.3. ALL TREE WORK PERFORMED SHALL MEET OR EXCEED THE MOST RECENT INDUSTRY STANDARDS, AS PUBLISHED BY THE INTERNATIONAL SOCIETY OF ARBORICULTURE (ISA).

2. PRE-CONSTRUCTION


- 2.1. PRIOR TO THE PRE-CONSTRUCTION MEETING, THE CONTRACTOR SHALL HAVE THE LIMITS OF CLEARING AND GRADING CLEARLY MARKED IN THE FIELD WITH FLAGGING. THESE LIMITS SHALL NOT EXCEED THOSE SHOWN ON THE APPROVED PLANS.
- 2.2. AFTER LIMITS HAVE BEEN STAKED, THE CONTRACTOR SHALL REQUEST A PRE-CONSTRUCTION MEETING WITH CITY OF FAIRFAX
- 2.3. DURING THE PRE-CONSTRUCTION MEETING, THE LIMITS MAY BE ADJUSTED TO BETTER PRESERVE OR REMOVE TREES IMPACTED BY CONSTRUCTION ACTIVITIES.

3. INSTALLATION OF TREE PROTECTION MEASURES

- 3.1. ROOT PRUNING: PRIOR TO CONSTRUCTION, ROOT PRUNING SHALL BE COMPLETED AT THE LIMITS. ROOT PRUNING SHALL BE TO THE DEPTH OF EIGHTEEN (18) TO TWENTY-FOUR (24) INCHES AND SHALL BE ACCOMPLISHED BY USING A TRENCHER, VIBRATING PLOW OR BY HAND. TRENCH SHOULD BE IMMEDIATELY BACKFILLED WITH REMOVED SOIL. WHEN EXCAVATING ALL TREE ROOTS GREATER THAN 1 INCH IN DIAMETER THAT ARE EXPOSED AND/OR DAMAGED SHALL BE TRIMMED CLEANLY, AND COVERED WITH ORGANIC MULCH, TOPSOIL, OR OTHER SUITABLE MATERIAL TO PREVENT THE EXPOSED ROOTS FROM DRYING
- 3.2. TREE PROTECTION FENCING: IMMEDIATELY FOLLOWING ROOT PRUNING, TREE PROTECTION FENCING SHALL BE COMPLETED AT THE LIMITS. TREE PROTECTION FENCING SHALL BE INSTALLED PER TREE PRESERVATION PLAN AND SHALL CONSIST OF EITHER OF THE FOLLOWING MATERIALS:
- 3.2.1. FOURTEEN (14) GAUGE WELDED WIRE MESH THAT IS A MINIMUM OF FOUR (4) FOOT TALL. THE MESH SHALL BE ATTACHED TO SIX (6) FOOT TALL, TWO-INCH (2") STEEL U-CHANNEL ANCHOR POSTS DRIVEN EIGHTEEN (18) INCHES INTO THE GROUND. THE POSTS SHALL BE PLACED NO FURTHER THAN TEN (10) FEET APART.
- 3.2.2. SUPER SILT FENCE
- 3.3. TREE PROTECTION SIGNAGE: BILINGUAL SIGNS STATING "TREE PRESERVATION AREA KEEP OUT" SHALL BE AFFIXED TO THE TREE PRESERVATION FENCE AT LEAST EVERY 50 FEET IMMEDIATELY FOLLOWING TREE PROTECTION FENCING INSTALLATION.
- 3.4. CITY OF FAIRFAX SHALL BE NOTIFIED AND GIVEN THE OPPORTUNITY TO INSPECT THE SITE TO ASSURE THAT ALL TREE PROTECTION DEVICES HAVE BEEN CORRECTLY INSTALLED. IF IT IS DETERMINED THAT THE FENCING HAS NOT BEEN INSTALLED CORRECTLY, NO CONSTRUCTION ACTIVITIES SHALL OCCUR UNTIL THE FENCING IS INSTALLED CORRECTLY, AS DETERMINED BY CITY OF FAIRFAX.
- 3.5. TREES BEING REMOVED SHALL NOT BE FELLED, PUSHED OR PULLED INTO TREE PRESERVATION AREAS. EQUIPMENT OPERATORS SHALL NOT CLEAN ANY PART OF THEIR EQUIPMENT BY SLAMMING AGAINST THE TRUNKS OF TREES TO BE DETAINED.
- 3.6. TREES ON THE EDGE OF THE LIMITS OF CLEARING AND GRADING SHALL BE CUT DOWN BY HAND WITH A CHAIN SAW. REMAINING STUMPS SHALL EITHER BE LEFT IN PLACE OR GROUND DOWN WITH A STUMP GRINDER.
- 3.7. TREES INDICATED WILL BE MULCHED WITH WOOD CHIPS GENERATED FROM ON SITE CLEARING OR TREE REMOVAL AND PRUNING OPERATIONS WHEN POSSIBLE. SHREDDED HARDWOOD MULCH FROM OFFSITE MAY BE UTILIZED IF APPROVED BY PROJECT ARBORIST. MULCH SHALL BE SPREAD IN A UNIFORM DEPTH OF THREE (3") INCHES BY HAND. MULCH SHALL BE PLACED IN AREAS AS INDICATED ON APPROVED PLANS.

4. CONSTRUCTION

- 4.1. DURING CLEARING AND GRADING OPERATIONS AND THROUGHOUT CONSTRUCTION, NO ACTIVITY SHALL BE PERMITTED IN TREE SAVE AREAS WITHOUT AUTHORIZATION FROM OWNER, ARBORIST, OR CITY OF FAIRFAX . PRECLUDED ACTIVITIES INCLUDE:
- 4.1.1. FELLING OF TREES INTO PRESERVATION AREAS OR OPERATION OF HEAVY MACHINERY IN SAVE AREAS TO FELL TREES ON THE PERIMETER OF PRESERVATION AREAS.
- 4.1.2. OPERATION OF HEAVY EQUIPMENT OR MACHINERY OF ANY KIND IN PRESERVATION AREAS FOR ANY PURPOSE.
- 4.1.3. PLACEMENT OF EXCESS SOIL, FILL, OR MATERIALS OF ANY KIND IN PRESERVATION AREAS.
- 4.1.4. PLACEMENT OF EXCESS SOIL, FILL, OR MATERIALS OF ANY KIND IN PRESERVATION AREAS.
- 4.1.5. PARKING OR STORING EQUIPMENT OR VEHICLES IN PRESERVATION AREAS.
- 4.1.6. DUMPING CHEMICALS OR CONCRETE WASHOUT IN PRESERVATION AREAS.
 4.1.7. BURNING OF ANY MATERIAL OR DEBRIS IN PRESERVATION AREAS OR WITHIN 200 FEET OF PRESERVATION AREAS.
- 4.1.8. TRENCHING, GRADING, EXCAVATING FOR ANY PURPOSE IN PRESERVATION AREAS.
- 4.2. ALL EXISTING TRASH AND/OR DEBRIS ON SITE SHALL BE REMOVED AT THE TIME OF DISTURBANCE. INDIVIDUAL TREES AND FORESTED AREAS DESIGNATED TO BE PRESERVED SHALL BE PROTECTED AND MANAGED TO ENSURE TREE SURVIVAL DURING ALL PHASES OF DEMOLITION, CLEARING AND GRADING, AND CONSTRUCTION. IN ADDITION TO PROTECTING TREES, ALL UNDERSTORY PLANTS, LEAF LITTER AND SOIL CONDITIONS FOUND IN FORESTED AREAS DESIGNATED TO BE LEFT PRESERVED SHALL BE PROTECTED.
- 4.3. TREES TO REMAIN LOCATED ALONG THE LIMITS OF CLEARING AND GRADING SHALL BE PRUNED DURING CLEARING OPERATIONS TO AVOID MECHANICAL DAMAGE. THIS SHALL BE ADMINISTRATED UNDER THE SUPERVISION OF AN ISA CERTIFIED ARBORIST.
- 4.4. ANY DAMAGE INFLICTED TO THE ABOVE OR BELOW-GROUND PORTIONS OF THE TREES SHOWED TO BE PRESERVED SHALL BE REPAIRED IMMEDIATELY PER ISA STANDARDS.
- 4.5. ALL PRUNING SHALL CONFORM TO THE LATEST EDITION OF ANSI A300 (PART 1) PRUNING STANDARDS. DISEASED LIMBS SHALL BE REMOVED OR TREATED AT THE DISCRETION OF THE ARBORIST. WHILE PRUNING, THE ARBORIST SHALL MAKE NOTE OF ANY CONDITIONS WHICH AFFECT THE HEALTH OR CONDITION OF THE TREE AND RECOMMEND CORRECTIVE TREATMENT FOR THESE CONDITIONS. VINE REMOVAL SHALL BE INCLUDED IN ALL PRUNING ACTIVITIES. UNDER NO CIRCUMSTANCES SHALL THE INTERIOR OF TREES BE STRIPPED OF FOLIAGE, SUCKERS, EPICORMIC BRANCHING, OR OTHER LIVE GROWTH. INTERIOR GROWTH MAY BE THINNED AS NECESSARY TO REMOVE BRANCHES DAMAGED DURING OPERATIONS. DEBRIS FROM PRUNING SHALL BE CHIPPED AND DEPOSITED INTO THE TREE SAVE AREA AND SPREAD BY HAND TO A UNIFORM THICKNESS OR BE REMOVED FROM SITE.

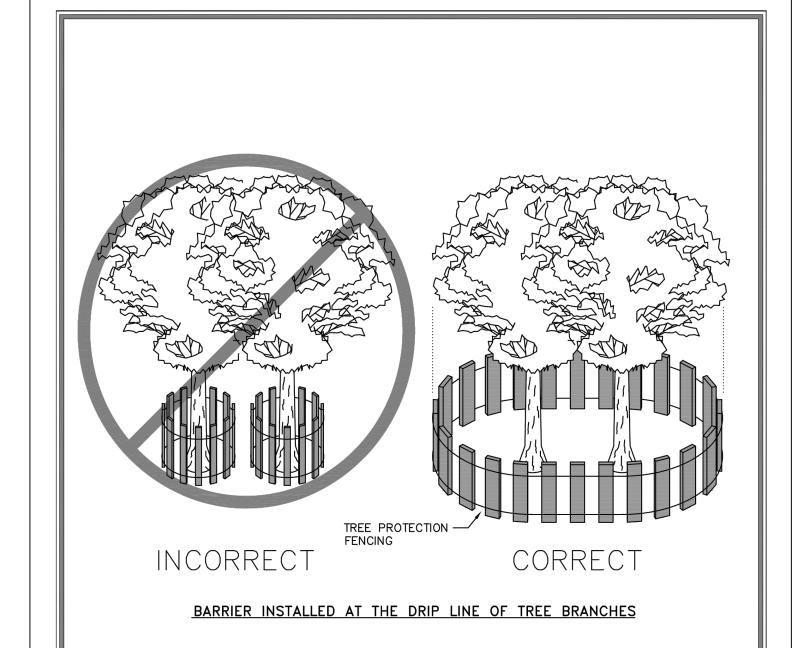

NOTES


- 1. Precautions shall be taken to prevent and minimize damage to trees. In such cases repair any damage to crown, trunk or root system
- immediately.

 A. Repair roots by cleanly cutting off the damaged areas. Spread peat me
- or moist topsoil over exposed roots.
 B. Repair damage to bark by trimming around the damaged area as shown in
- Detail 8.10. Taper the cut to provide drainage.

 C. Cut off damaged tree limbs above the tree collar at the trunk or main branch.


 Use three separate cuts as shown in Detail 8.10 to avoid peeling bark from healthy areas of tree.

OI FAIRIAN 1805	Department of Public Works 10455 Armstrong Street Fairfax, VA 22030-3630	CITY of FAIRFAX USE WITH THE FAIRFAX STANDARD SPECIFICATIONS ONLY	Voice (703) 385-7810 FAX (703) 591-5727 www.fairfaxva.gov	
	STANDARD TREE		SCALE: Not To Scale	DETAIL# 8.09
	PRO'	TECTION DETAIL	REVISION DATE: December 2016	SHEET #:1 of2

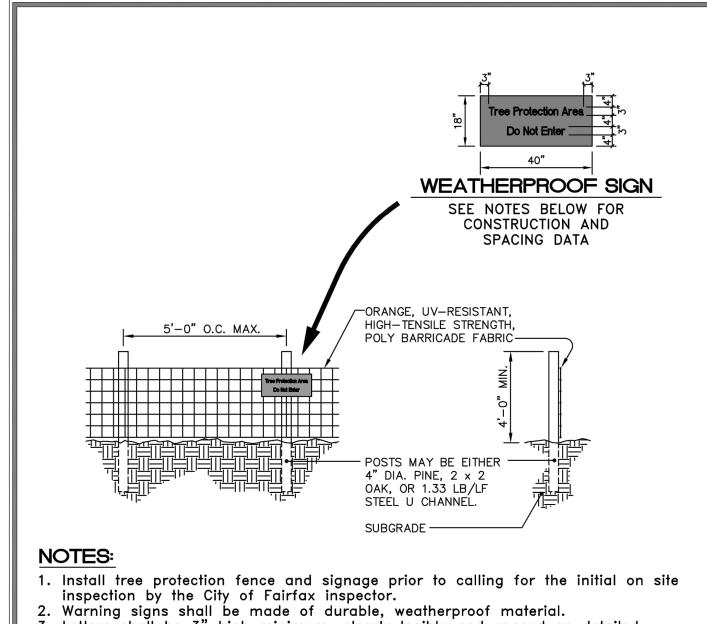


- 3. Letters shall be 3" high minimum, clearly legible and spaced as detailed.
 4. Signs shall be placed no greater than 75' on center or as approved.
- 5. For tree protection areas less than 200' in perimeter, provide no less than three signs per protected area.
- 6. Attach signs securely to fence posts and fabric.
- 7. Maintain tree protection fence throughout duration of project.
- 8. Additional signs may be required by City of Fairfax inspections based on actual field conditions.
- 9. No activity shall occur within the protected area including material storage, stockpiling, parking or any activity that may compact the ground or damage the trees.
- 10. The City reserves the right to require a 4' to 6' height chain link fencing for identified trees, such as specimen or champion trees, to maximize the protection of the tree and its critical root zone.

OI IAIRIA 1865	Department of Public Works 10455 Armstrong Street Fairfax, VA 22030-3630 CITY of FAIRFAX USE WITH THE FAIRFAX STANDARD SPECIFICATIONS ONLY		Voice (703) 385-7810 FAX (703) 591-5727 www.fairfaxva.gov	
	STANDARD TREE		SCALE: Not To Scale	DETAIL# 8.09
	PRO'	TECTION DETAIL	REVISION DATE: December 2016	SHEET #: of

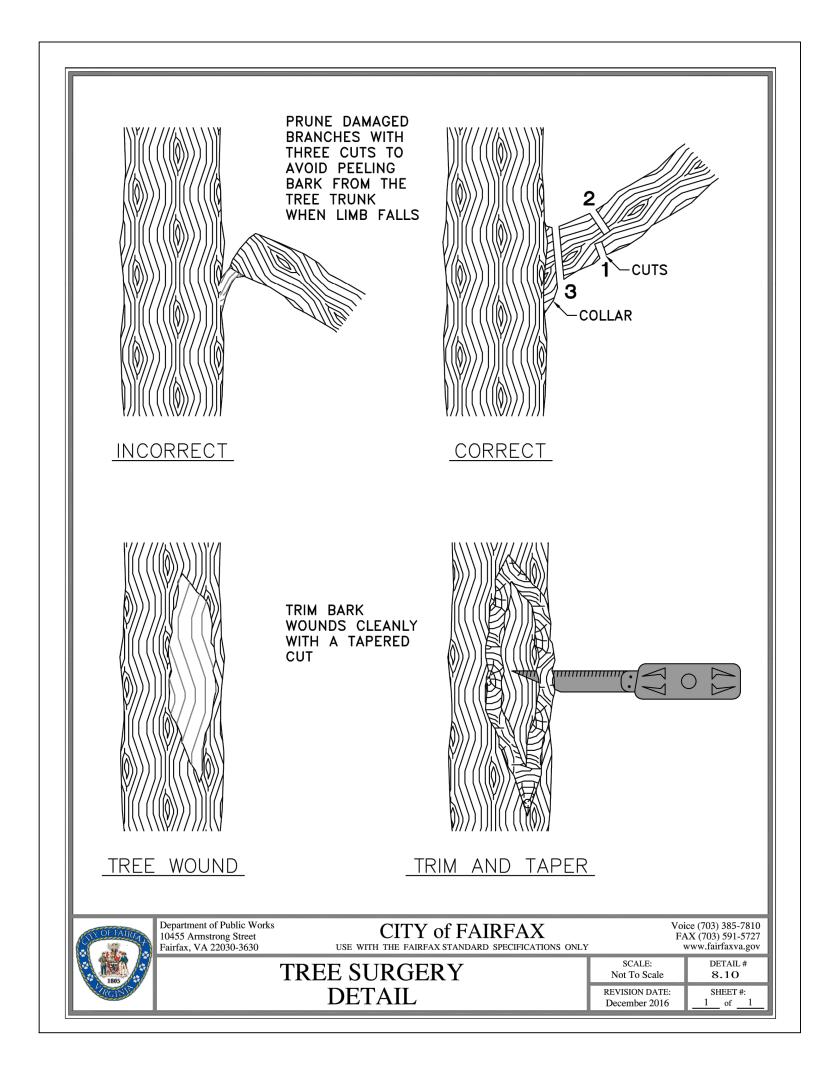



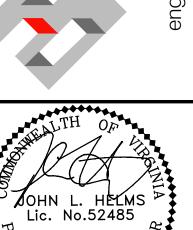

29 APARTMENTS
RAL DEVELOPMENT PLAN

1 11-30 -2022 ADDRESSED PER CITY COMMENTS

ARK DATE DESCRIPTION

PROJECT No.: 21082.002.00 DRAWING No.: 111772 DATE: 2022-07-15 SCALE: N/A DESIGN: LBD DRAWN: AH

SHEET TITLE:

CHECKED: JM

TREE
MANAGEMENT
NOTES & DETAILS

SHEET No.

PI_311

