



N29 (at WillowWood) Eaton Place at University Drive Extension

The N29 project is located on the north side of Eaton Place between Fairfax Boulevard (to the East) and Chainbridge Road (to the West) and is to the northeast of the recently completed University Drive Extension. The existing site is comprised of all surface parking.

Adjacent to the site to the east and west are commercial office buildings and surface parking. To the north of the site is an existing parking structure (two levels).

The proposed development involves removing the existing surface parking and the construction of a new multifamily mixed-use building and structured parking garage. The proposed multifamily building has a total area of 289,542 GSF with a total of 260 units. The structured parking garage has a total area of 199,800 GSF with a total of 676 parking spaces, which will be shared between the proposed multifamily building and one of the existing commercial office buildings at WillowWood Plaza.

The architectural design for the proposed multifamily building consists of a clear and modest massing composition. The massing strategy incorporates a setback at the southwest corner, aligned across from the University Blvd intersection and creates an open plaza space. This primary corner is further accented with an increased height, change in color, and variation of material texture and will incorporate a retail space at the ground floor level. A variety of textures and materials further emphasize strong massing volumes, with a primarily masonry base providing a grounding effect and vertical fiber cement above implying a lightness floating above and extending verticality. The primary common and amenity spaces for the multifamily building are aligned to face along Eaton Place along with the corner retail space to create multiple layers of experiences, engagement, and activation.


















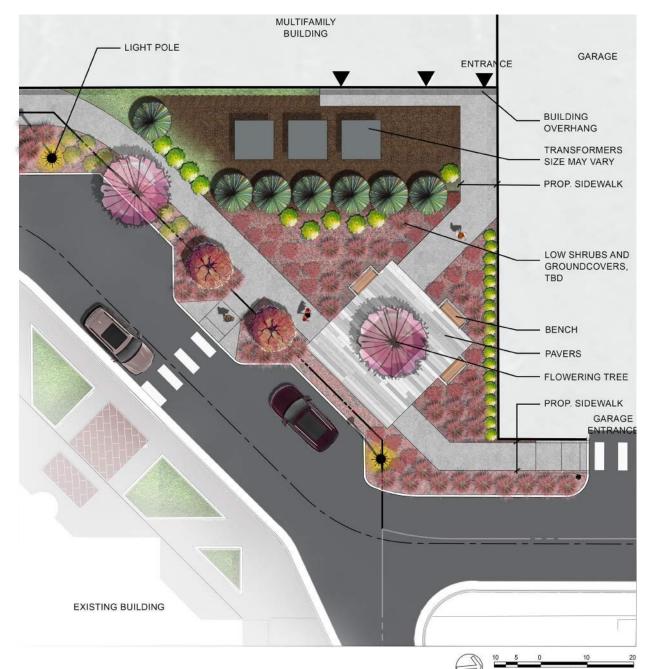

PRECEDENT IMAGERY:











PLEASE NOTE; ANY INFORMATION SHOWN ON THIS PAGE IS FOR ILLUSTRATIVE PURPOSES ONLY, PROVIDED TO DESCRIBE THE GENERAL CONCEPT OF THE DESIGN. FINAL DESIGN WILL LIKELY VARY FROM WHAT IS SHOWN ABOVE.








1. This conceptual landscape plan is for illustrative purposes only, final layout will be determined by final architecture and engineering at time of site

Drawing #: 112343

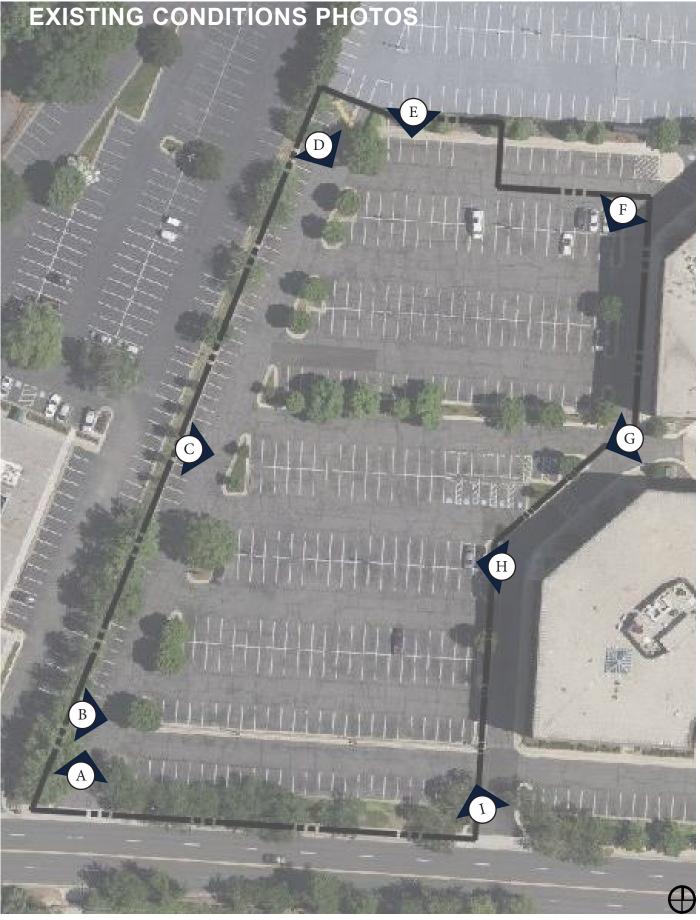



A VIEW LOOKING NORTH FROM WEST SITE ENTRANCE



B VIEW LOOKING EAST FROM WEST SITE ENTRANCE



C VIEW LOOKING EAST FROM SITE INTERIOR



D VIEW LOOKING SOUTH
EAST FROM EXISTING
PARKING GARAGE ADJACENT
ENTRANCE



E VIEW LOOKING SOUTH FROM ADJACENT EXISTING PARKING GARAGE




F VIEW LOOKING SOUTH FROM NORTH EAST SITE CORNER



G VIEW LOOKING SOUTH WEST FROM ADJACENT OFFICE BUILDING



H VIEW LOOKING WEST FROM ADJACENT OFFICE BUILDING

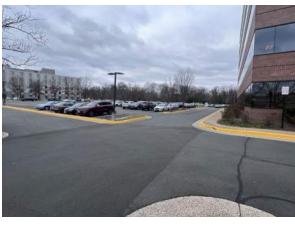

VIEW LOOKING NORTH FROM EAST SITE ENTRANCE







City of Fairfax



AFB-1; **BRICK - WHITE** MORTAR - ARCTIC WHITE

AFB-2;

CON-1;

BRICK - BLACK

MORTAR - SMOKE

PRECAST CONCRETE



FCP-1: FIBER CEMENT BOARD AND BATTEN DARK GRAY

FIBER CEMENT LAP SIDING

FIBER CEMENT BOARD AND BATTEN

FCP-2;

WHITE

WHITE

FCP-2 ALT;



FCP-3: FIBER CEMENT PANEL WHITE



FCP-4: FIBER CEMENT PANEL **GRAY**



FCP-5; FCP-1 ALT FIBER CEMENT LAP SIDING **DARK GRAY**







FCP-6; WOOD TONE PANEL



GW-1; **GREEN WALL SYSTEM**

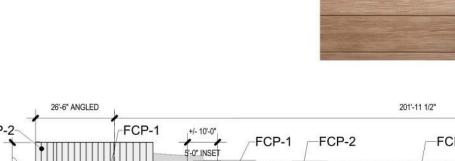

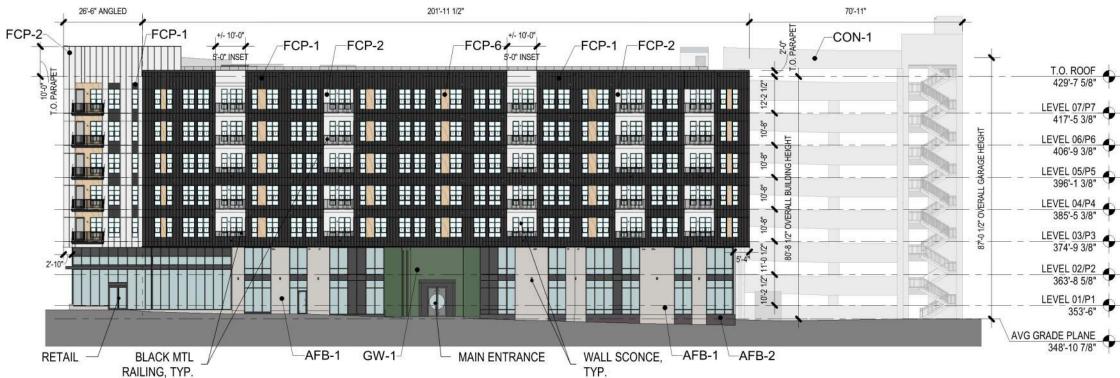



purposes only, final layout will be determined by

final architecture and engineering at time of site



Drawn/Checked: HC

Drawing #: 112343

Project #: 21082.002.00





KEY PLAN

A EATON PLACE

SUBJECT TO CHANGE



AFB-1; BRICK - WHITE MORTAR - ARCTIC WHITE



AFB-2; BRICK - BLACK MORTAR - SMOKE



CON-1; PRECAST CONCRETE



FCP-1; FIBER CEMENT BOARD AND BATTEN DARK GRAY



FCP-2; FIBER CEMENT BOARD AND BATTEN WHITE



FCP-2 ALT; FIBER CEMENT LAP SIDING WHITE



FCP-6; WOOD TONE PANEL



FCP-3; FIBER CEMENT PANEL WHITE




FCP-4; FIBER CEMENT PANEL GRAY



FCP-5; FCP-1 ALT FIBER CEMENT LAP SIDING DARK GRAY




GW-1; GREEN WALL SYSTEM

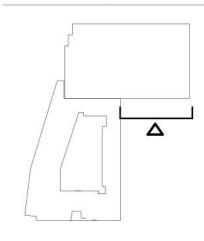

KEY PLAN

EATON PLACE

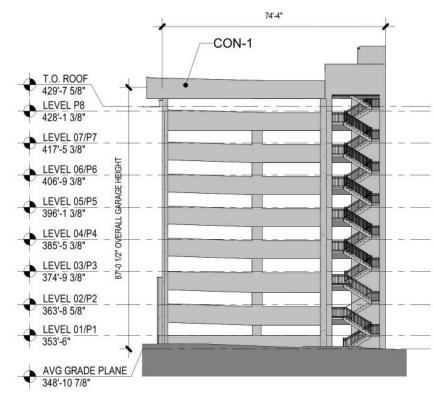









AFB-1; **BRICK - WHITE** MORTAR - ARCTIC WHITE



FCP-1: FIBER CEMENT BOARD AND BATTEN DARK GRAY

FCP-2;


WHITE



FCP-3: FIBER CEMENT PANEL WHITE



FCP-4: FIBER CEMENT PANEL **GRAY**

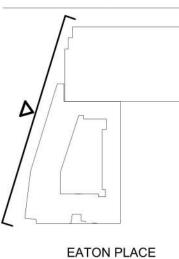

KEY PLAN

CON-1;

AFB-2;

BRICK - BLACK

MORTAR - SMOKE





FCP-2 ALT; FIBER CEMENT LAP SIDING WHITE

FIBER CEMENT BOARD AND BATTEN



FCP-5; FCP-1 ALT FIBER CEMENT LAP SIDING **DARK GRAY**



FCP-6: WOOD TONE PANEL



WALL SCONCE,

TYP.

RETAIL -

GW-1; **GREEN WALL SYSTEM**

FCP-1





RETAIL -

BLACK MTL

RAILING, TYP.





348'-10 7/8"

LEVEL 00/P0 342'-4"





LOADING

WALK-UP UNITS - AFB-2

AVG GRADE PLANE 348'-10 7/8"

SUBJECT TO CHANGE



AFB-1; BRICK - WHITE MORTAR - ARCTIC WHITE

AFB-2;

CON-1;

BRICK - BLACK

MORTAR - SMOKE

PRECAST CONCRETE



FCP-1; FIBER CEMENT BOARD AND BATTEN DARK GRAY

FCP-2;


WHITE



FCP-3; FIBER CEMENT PANEL WHITE



FCP-4; FIBER CEMENT PANEL GRAY

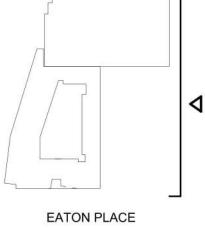

KEY PLAN



FCP-2 ALT; FIBER CEMENT LAP SIDING WHITE

FIBER CEMENT BOARD AND BATTEN




FCP-5; FCP-1 ALT FIBER CEMENT LAP SIDING DARK GRAY



FCP-6; WOOD TONE PANEL



GW-1; GREEN WALL SYSTEM

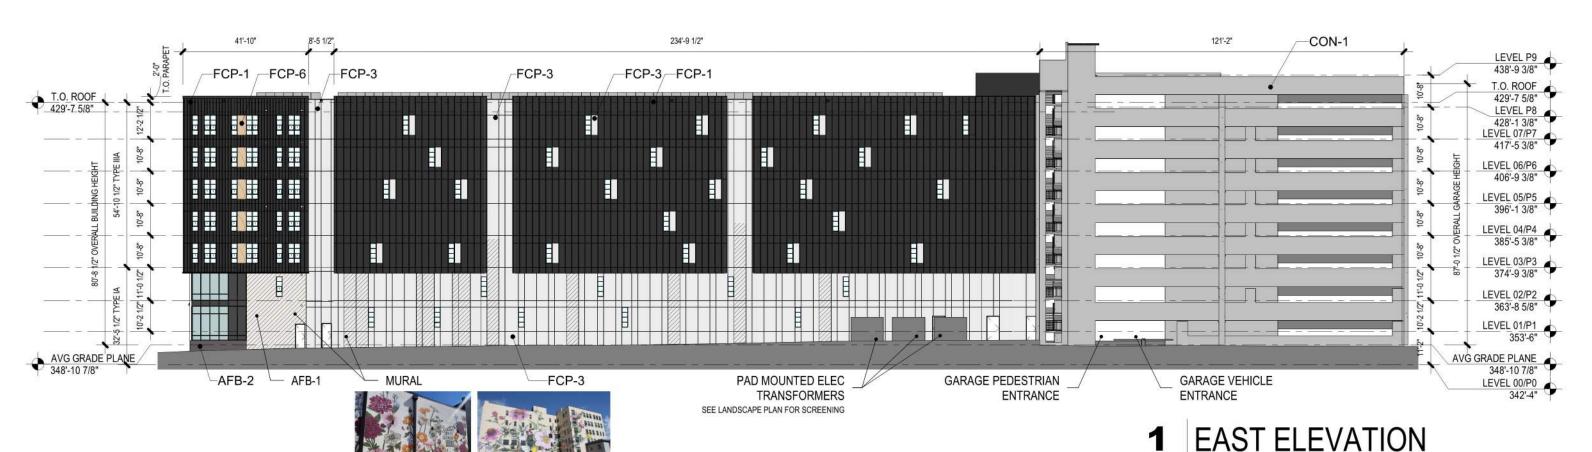







MURAL PRECEDENT

1/32" = 1'-0"

16'

0

32'



EXAMPLE MURAL CONTENT AND PLACEMENT

















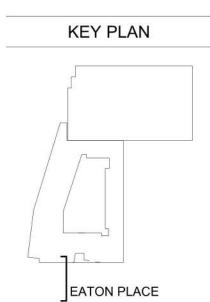

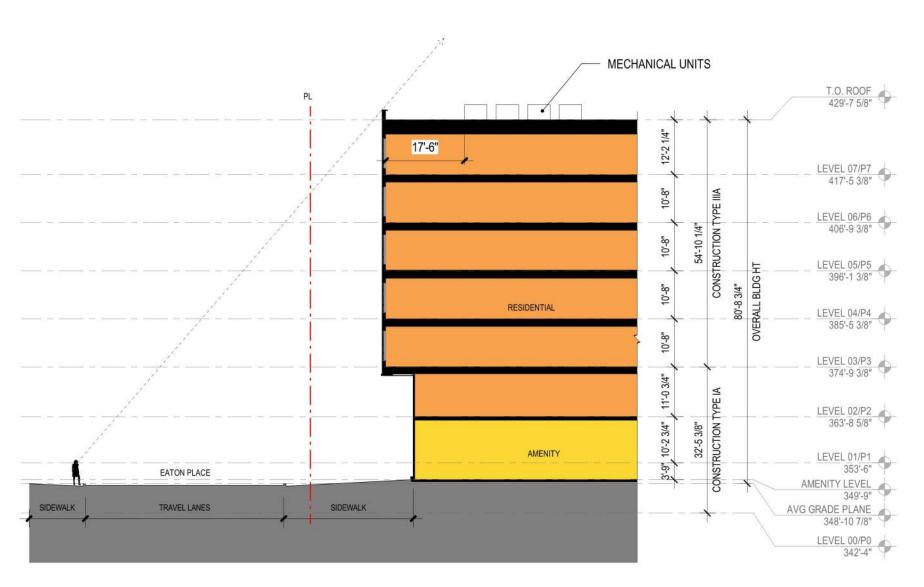



1 N-S SIGHTLINE SECTION







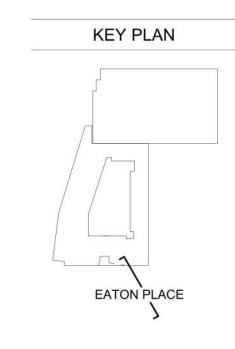

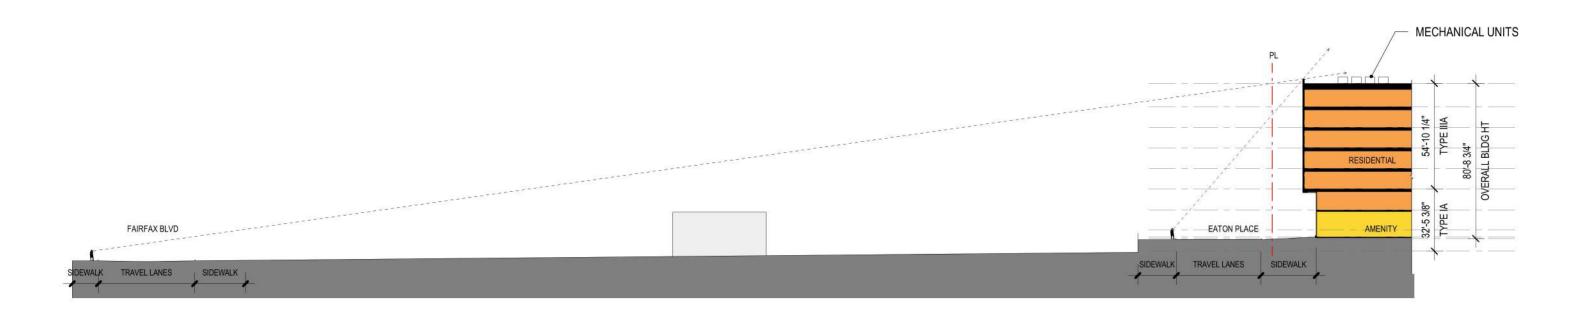


N-S SIGHTLINE SECTION TO FAIRFAX BLVD

1" = 50'-0" 0 50' 100'







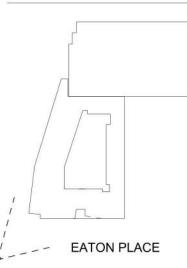




N29 Apartments

City of Fairfax







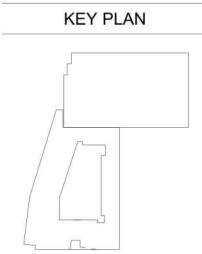

- EATON PLACE




N29 Apartments

City of Fairfax







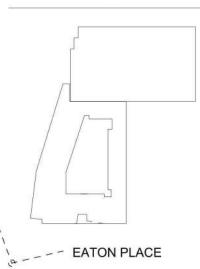




N29 Apartments

City of Fairfax





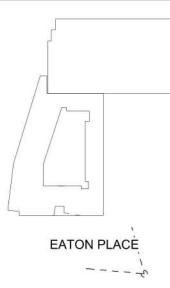




N29 Apartments

City of Fairfax








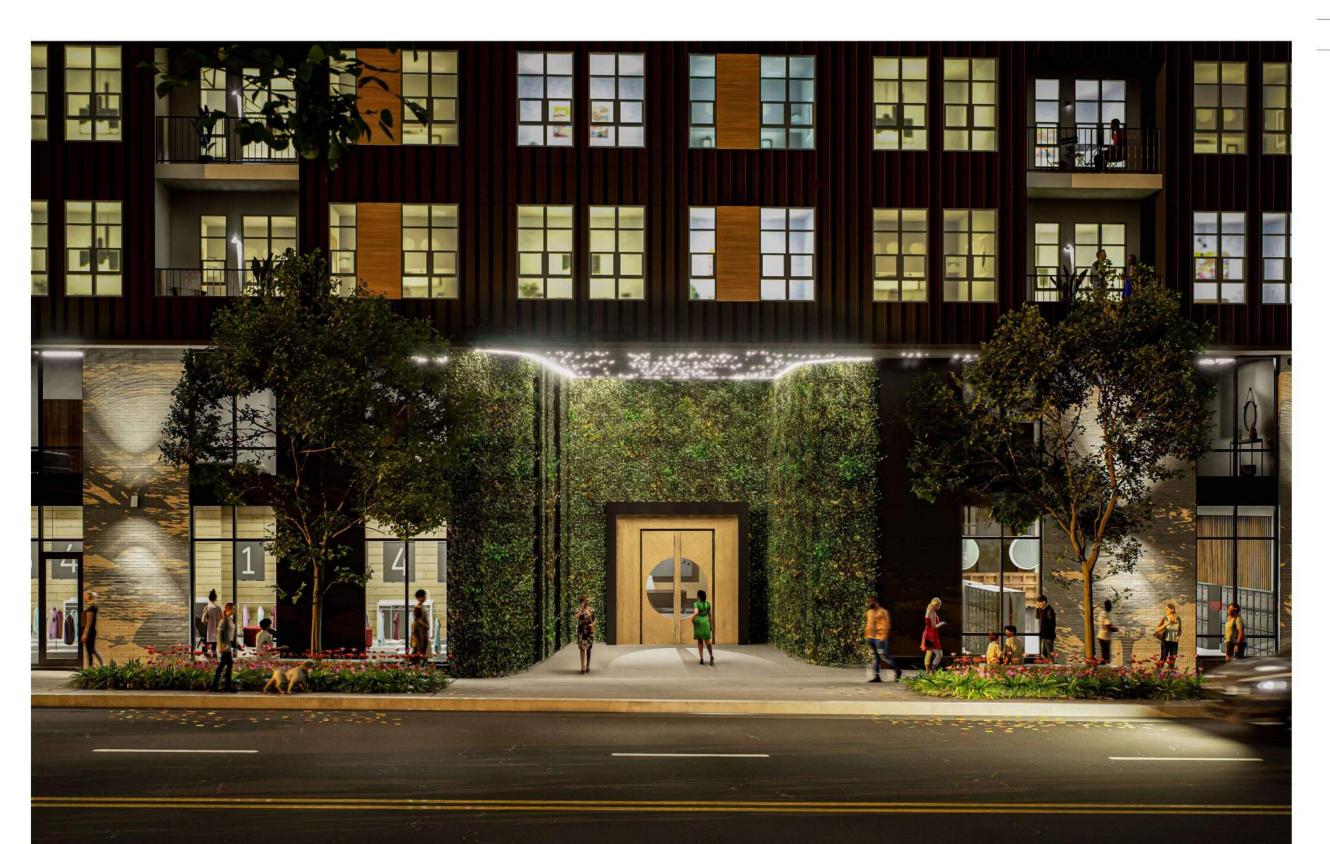




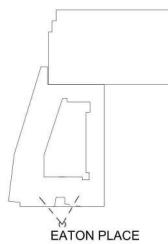






City of Fairfax

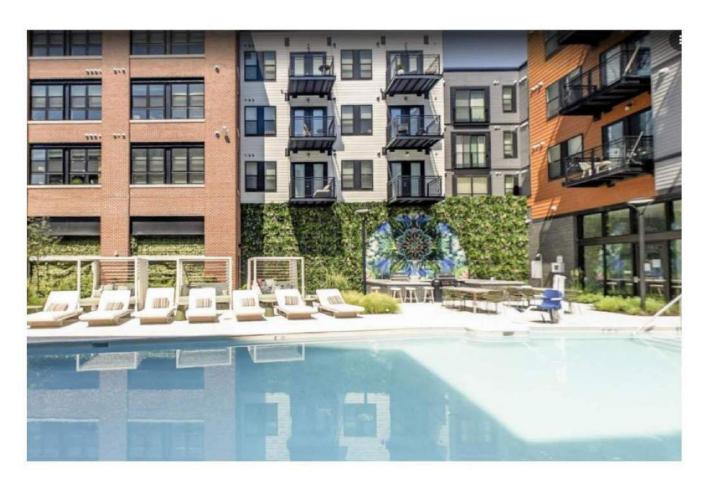

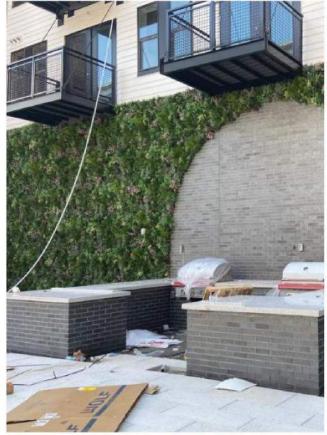

BECKERT'S PARK

1350 E St, SE, Washington DC

Installed: Spring 2020

Product Info: Vistafolia Artificial Green Walls

- -Suitable for all weathers
- -No maintenance
- -UV & IFR Technology
- -Fully customizable in color, texture, and shape
- -overlapping foliage to eliminate joins
- -varying heights of planting













N29 Apartments

City of Fairfax



UPWARD AND DOWNWARD BEAM LIGHTS LOCATION: BRICK PIERS



DIRECTED DOWNLIGHT LOCATION: BALCONIES



PINHOLE STARLIGHTS LOCATION: MAIN ENTRANCE SOFFIT







SITE PLAN RENDERING/ LANDSCAPE PLAN





OBJECT

BENCHES

TRASH RECEPTACLES

SYMBOL

BOTANICAL NAME

COMMON NAME

Scarlet Oak

QTY

Armstrong Red Maple





N29 Apartments
Board of Architectural Review
City of Fairfax



Notes:


1. This conceptual landscape plan is for illustrative purposes only, final layout will be determined by final architecture and engineering at time of site

Date: 12-04-2023

Drawn/Checked: SA/CM

Project #: 21082.002.00

Drawing #: 112343

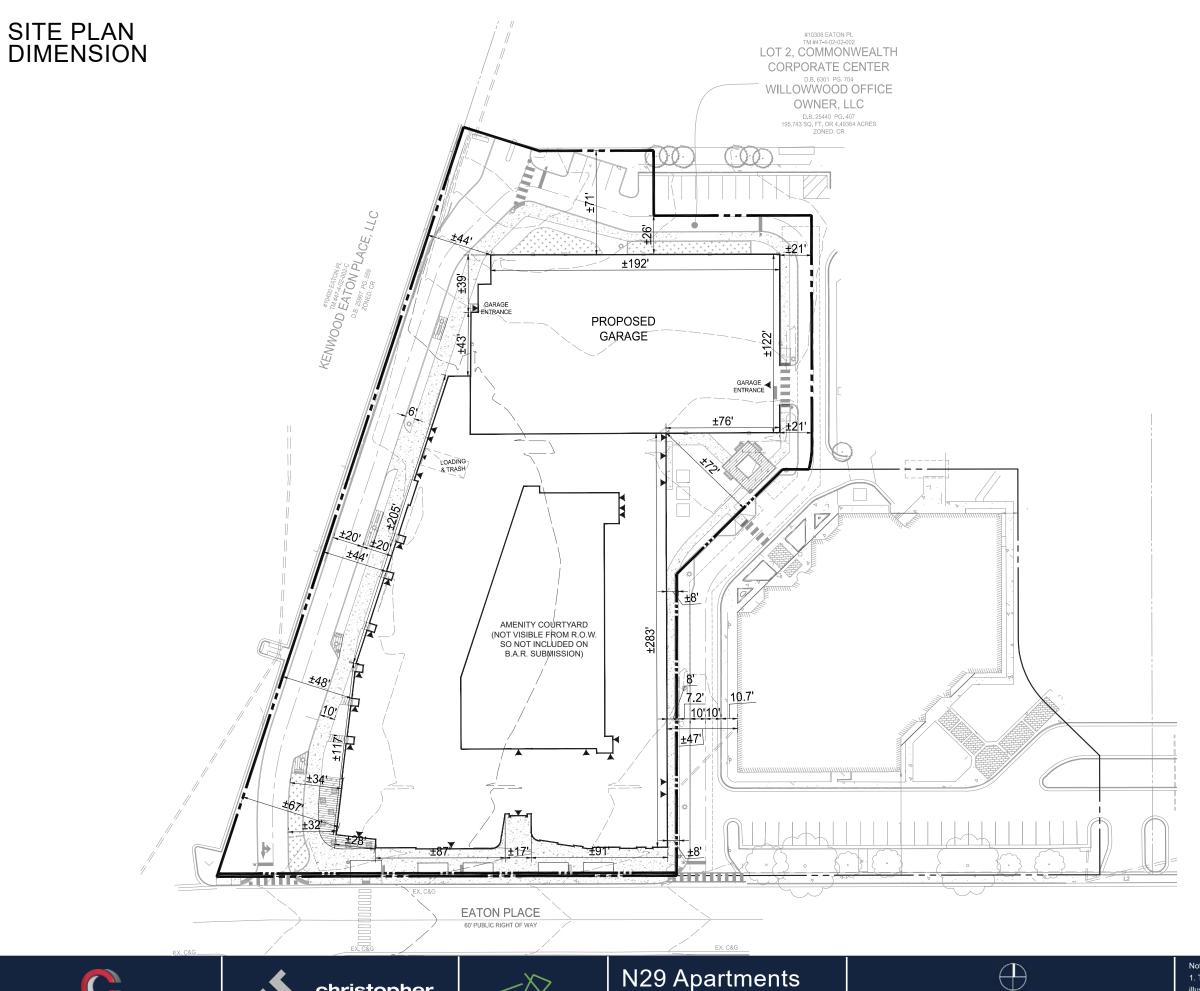







N29 Apartments
Board of Architectural Review
City of Fairfax



Notes:

1. This conceptual site dimension plan is for illustrative purposes only, final layout will be determined by final architecture and engineering at time of site plan.

Date: 12-04-2023
Drawn/Checked: SA/CM
Project #: 21082.002.00
Drawing #: 112343

PLANTS PALETTE CANOPY TREES - DECIDUOUS



scarlet oak **EVERGREEN TREES**



green giant arborvitae thuga occidentalis 'nigra'



SHRUBS AND GROUNDCOVERS

gro-low fragrant sumac rhus aromatica 'gro-low'



duraheat river birch



princeton sentry ginkgo UNDERSTORY TREES - DECIDUOUS



willow oak quercus phellos



swamp white oak



armstrong red maple acer rubrum 'armstrong'



eastern redbud



saucer magnolia magnolia soulangiana



flowering dogwood cornus florida



otto luyken laurel prunus laurocerasus 'otto luyken'



lemon lime heuchera heuchera x 'lemon lime'



evergreen giant liriope liriope 'evergreen giant



schipka english laurel prunus laurocerasus 'Schipkaensis'







N29 Apartments **Board of Architectural Review** City of Fairfax



STREET LIGHT FIXTURES

- A MODERN DARK-SKY FRIENDLY LED FIXTURE WITH TRADITIONAL TOUCHES
- CITY RECOMMENDED FIXTURE LED POST-TOP ACORN LIGHT

SITE FURNISHINGS/ HARDSCAPE SELECTIONS

BENCHES

FORMS+SURFACES VECTOR BENCH

- MATERIAL: ALUMINUM
 COLOR: ALUMINUM TEXTURE
 OR EQUAL



TRASH RECEPTACLES

FORMS+SURFACES

- MATERIAL: ALUMINIUM
- FINISH: POWDERCOAT
- COLOR: ALUMINUM TEXTURE
- OR EQUAL

CROSSWALK

• WHITE 'LADDER-STYLE' CROSSWALKS, AS SHOWN





BIKE RACK

FORMS+SURFACES OLYMPIA

- COLOR: ALUMINUM TEXTURE VARIED CONFIGURATION OPTIONS
- OR EQUAL

ACCENT PAVERS

HANOVER PLANK PAVERS

- SIZE: 6' x 18'
- COLOR: CHARCOAL & LIMESTONE GRAY
- OR EQUAL












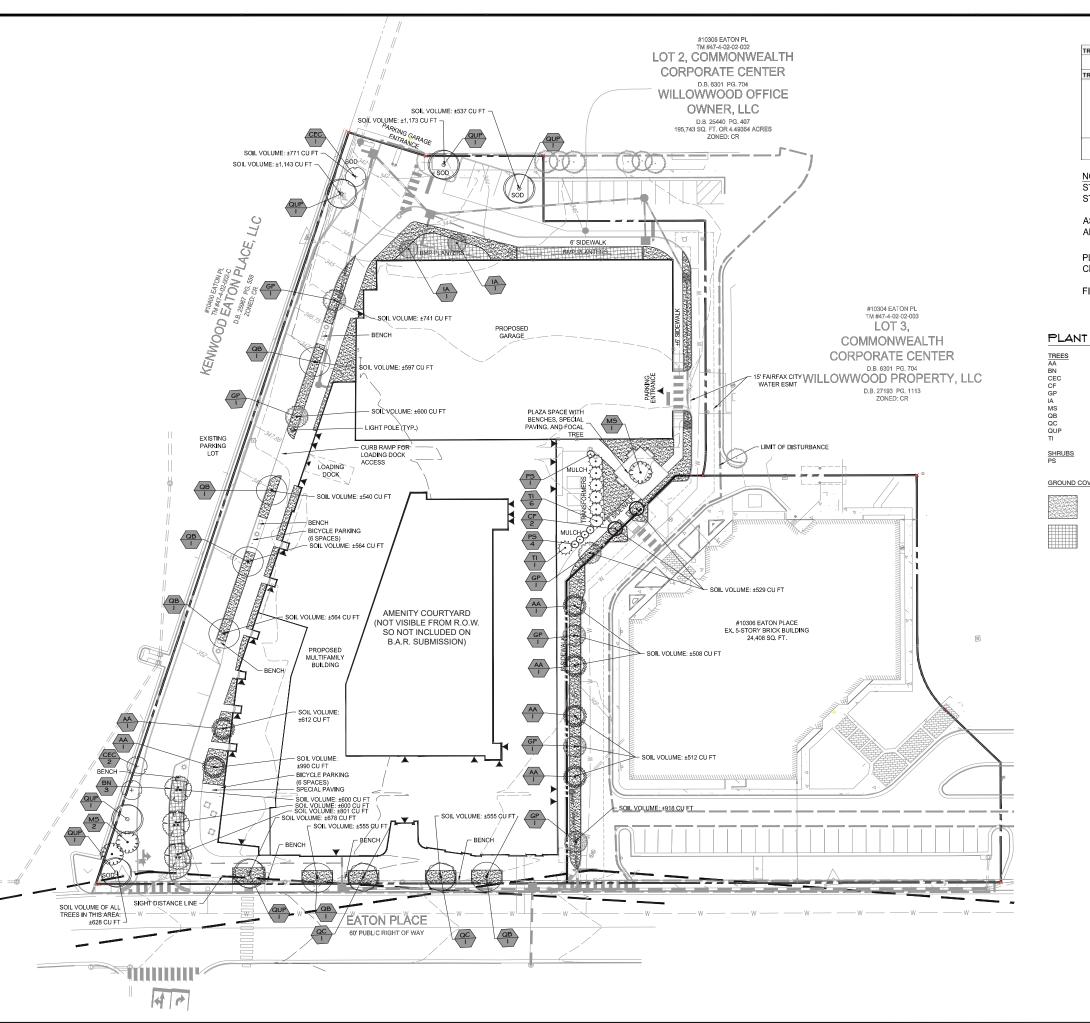

10-YEAR TREE CANOPY CALCULATIONS

GROSS SITE AREA TREE CANOPY COVERAGE REQUIRE		129130.81 SF NO REQUIREMENT		
REE CANOPY PROVIDED				
PLANT TYPE	STOCK SIZE	QUANTITY	CANOPY PER TREE	CANOPY PER TYPE
CATEGORY IV-DECIDUOUS	3" CALIPER	14	250 SF	3,500 SF
CATEGORY III-DECIDUOUS	3" CALIPER	3	175 SF	525 SF
CATEGORY II-DECIDUOUS	3" CALIPER	8	125 SF	1,000 SF
CATEGORY I-DECIDUOUS	3" CALIPER	12	75 SF	900 SF
CATEGORY II-EVERGREEN	6' HT	2	100 SF	200 SF
CATEGORY LEVERGREEN	8' HT	7	50 SF	350 SF
SUBTOTAL CANOPY AREA PROVIDE	D THROUGH TREE PLA	NTING		6,475 SF
TOTAL CANOPY AREA PROVIDED				6,475 SF
TOTAL CANOPY COVERAGE PROVI	DED			5.0 %

 $\frac{\text{NOTES}}{\text{STREET TREES ARE BEING PROVIDED TO EXTENT POSSIBLE AS DISCUSSED WITH CITY}}$ STAFF.

AS PER ZONING ORDINANCE §4.5.5.C.1, TRANSITIONAL YARDS ON THE WEST, NORTH AND EAST SIDE ARE NOT REQUIRED.

PLANTING SCHEDULE MAY CHANGE AT TIME OF SITE PLAN, WITH REVIEW BY CITY URBAN FORESTER.

FINAL DESIGN MAY VARY BASED ON FINAL ENGINEERING.

PLANT SCHEDULE

	1120	7			
TREES	QTY 6	BOTANICAL NAME	COMMON NAME	SIZE	CANOPY
AA	6	Acer rubrum 'Armstrong'	Armstrong Red Maple	3" Cal.	75 SF
BN	3	Betula nigra `BNMTF` TM	Dura Heat River Birch	3" Cal.	175 SF
CEC	3	Cercis canadensis	Eastern Redbud	3" Cal.	125 SF
CF	2	Cornus florida	Flowering Dogwood	3" Cal.	125 SF
GP	6	Ginkgo biloba `Princeton Sentry`	Princeton Sentry Maidenhair Tree	3" Cal.	75 SF
IA	2	llex opaca	American Holly	8` HT	100 SF
MS	3	Magnolia x soulangeana	Saucer Magnolia	3" Cal.	125 SF
QB	6	Quercus bicolor	Swamp White Oak	3" Cal.	250 SF
QC	2	Quercus coccinea	Scarlet Oak	3" Cal.	250 SF
QUP	6	Quercus phellos	Willow Oak	3" Cal.	250 SF
TI	7	Thuja x 'Green Giant'	Green Giant Arborvitae	8' HT	50 SF
SHRUBS	QTY 5	BOTANICAL NAME	COMMON NAME	SIZE 4`HT	
PS	5	Prunus laurocerasus 'Schipkaensis'	Schipka English Laurel	4` HT	
GROUND COVERS	CODE	BOTANICAL NAME	COMMON NAME	SIZE	
	SG	LOW SHRUBS AND GROUNDCOVERS, TBD		TBD	
	SWM	STORMWATER BMP PLANTINGS, TBD		TBD	



christopher
Consultants
4035 ridge top road p 703.273.6820
suite 601
fairfax, va 22030




N29 APARTMENTS GENERAL DEVELOPMENT PLAN CITY OF FAIRFAX,

PROJECT No.: 21082.002.00 DRAWING No.: 111772 DATE: 2022-07-15 SCALE: 1" = 30' DESIGN: CMZY DRAWN: ZY

SHEET TITLE:

LANDSCAPE PLAN

PI_910

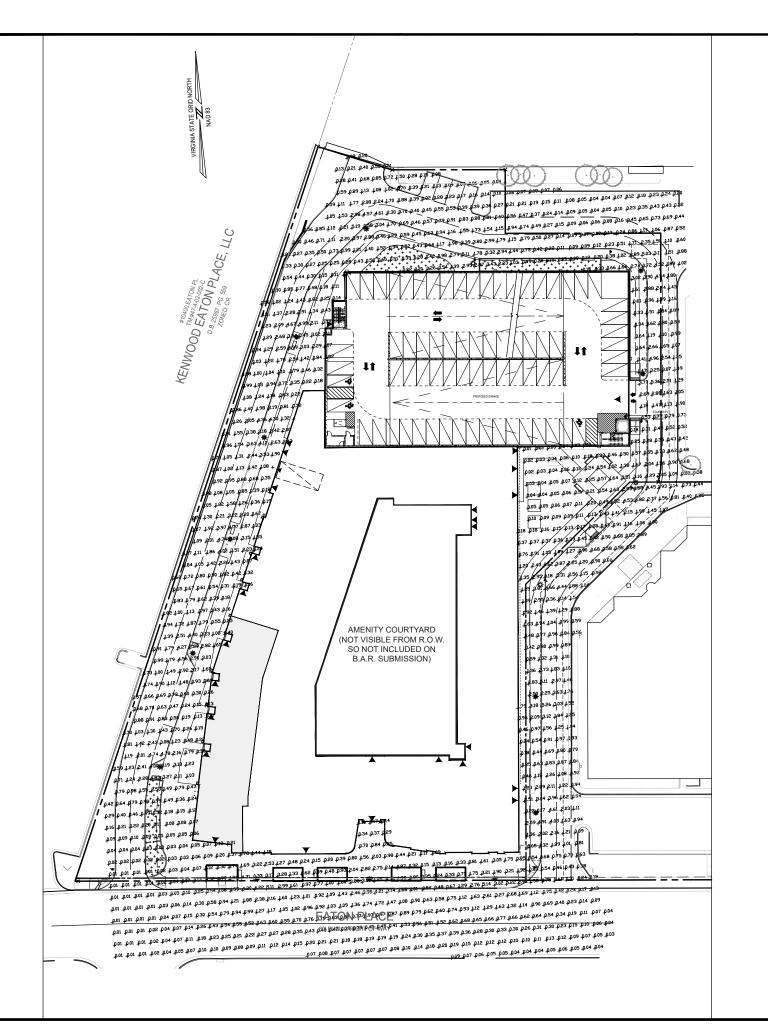

Numeric Summary								
Project: WILLOWWOOD								
Label	Calc. Type	Units	Avg.	Max	Min.	Avg./Min.	Max/Min.	
WEST	Illuminance	Fc	1.00	5.35	0.01	99.57	535.00	
NORTH	Illuminance	Fc	0.57	5.28	0.04	14.33	132.00	
EAST	Illuminance	Fc	0.57	5.36	0.01	57.38	536.00	
SOUTH	Illuminance	Fc	0.56	5.31	0.04	14.07	132.75	

Luminaire Schedule						
Project: Willowwood			10			
Symbol	Qty.	Arrangement	Lumens (Nominal)	Description		
₩.	16	Single	11,500	Prop. LED Acorn - 14 ft Pole - Type III		

christophe
CONSUltants
4035 ridge top road p 703.273.
sulte 601
fairfax, va 22000

ΘĽ

N29 APARTMENTS GENERAL DEVELOPMENT PLAN

CITY OF FAIRFAX, VA

11-30-2022 04-28-2023 08-11-2023 10-16-2023

PROJECT No.: 21082.002.00 DRAWING No.: 111772 DATE: 2022-07-15 SCALE: AS SHOWN DESIGN: LBD,ZY DRAWN: ZY CHECKED: JR

SHEET TITLE:

LIGHTING PLAN

PI_950